
# HOUSE EXPANSION - SECOND FLOOR ADDITION

# 30 GROVE ST, TOPSFIELD MA 01983



**EXISTING HOUSE.** 

# **AERIAL VIEW**

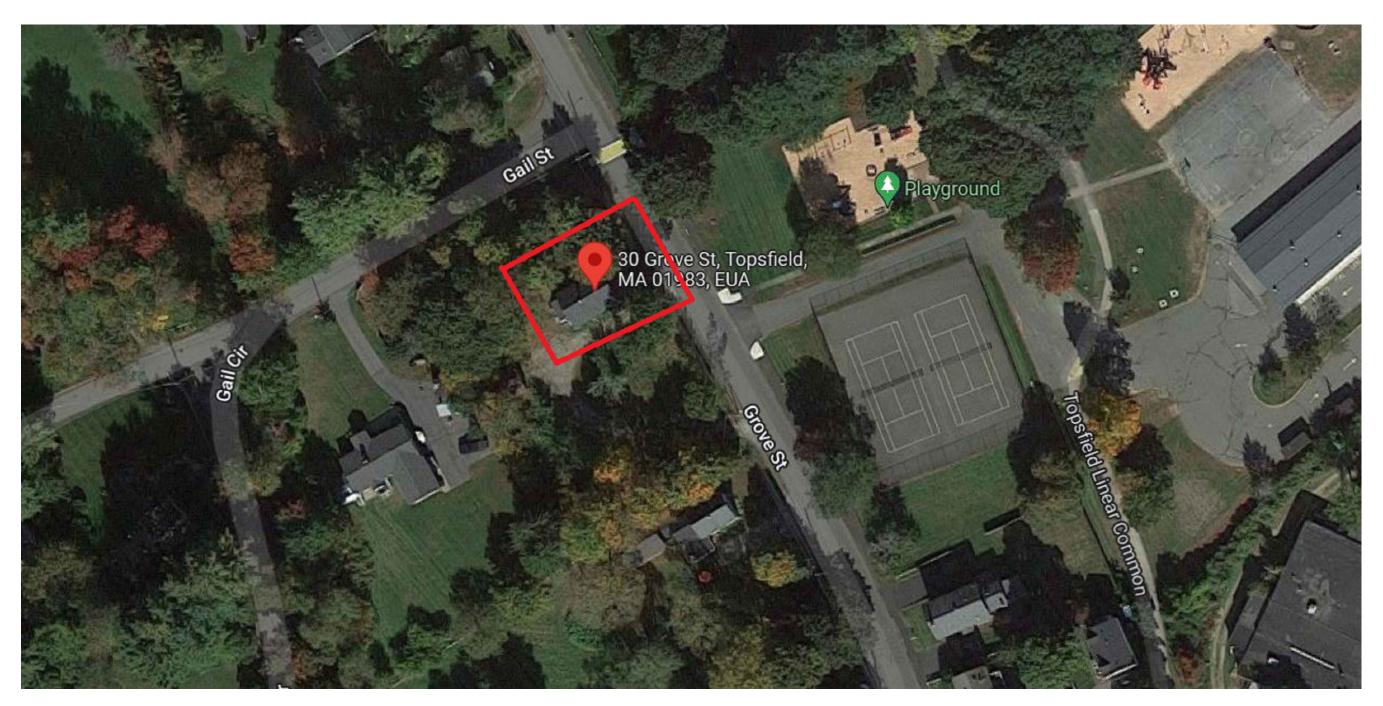

## GENERAL NOTES:

- 1. THE CONTRACTOR OR OWNER IS RESPONSIBLE FOR OBTAINING AND PAYING FOR ALL PERMITS REQUIRED FOR THIS PROJECT.
- 2. ALL WORK SHALL BE PERFORMED IN ACCORDANCE WITH THE COMMONWEALTH OF CURRENT MASSACHUSETTS STATE BUILDING CODE (IBC 2015, 780 CMR 9TH EDITION) AND OTHER APPLICABLE CODES.
- 3. THE CONTRACTOR IS SOLELY RESPONSIBLE FOR MEANS, METHODS, TECHNIQUES, SEQUENCING, SCHEDULING AND SAFETY FOR THIS PROJECT.
- 4. DIMENSIONS ARE NOT GUARANTEE, THE CONTRACTOR SHOULD VERIFY ALL DRAWING DIMENSIONS BEFORE PERFORM WORK.
- 5. THE CONTRACTOR SHALL WARRANTEE HIS WORK FOR A PERIOD OF ONE YEAR FROM THE DATE OF FINAL COMPLETION.
- 6. THE CONTRACTOR SHALL REPORT ANY DISCREPANCIES BETWEEN DRAWINGS SPECIFICATIONS OR FIELD CONDITIONS TO T DESIGN IMMEDIATELY.
- 7. CONCRETE AND REBAR STRENGTH SHALL HAVE MINIMUM OF 3,000 PSI AND 60,000 PSI RESPECTIVELY
- 8. NEW WINDOW MUST HAS DOUBLE PANE AND U FACTOR = 0.27

SCOPE OF WORK:

ARCHITECTURAL INTERIOR RENOVATION OF EXISTING SINGLE FAMILY DWELLING.

SECOND FLOOR ADDITION.



71B CLINTON ST Malden, MA 02148 Tel: 617 318-6056

PROJECT NAME HOUSE EXPANSION 30 GROVE ST, TOPSFIELD MA 01983

GIOVANI

Dosignor

Engineer no Nazieh R. Ham 857 312-9212

No. Description Date

00 Issue for Permit 05/26/2022

DRAWING TITLE

COVER PAGE.

DRAWING INFORMATION



May 26, 2022

DATE OF ISSUE

COVER PAGE.

DESCRIPTION

NOT TO SCALE.

SCALE


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PROJECT #


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A100






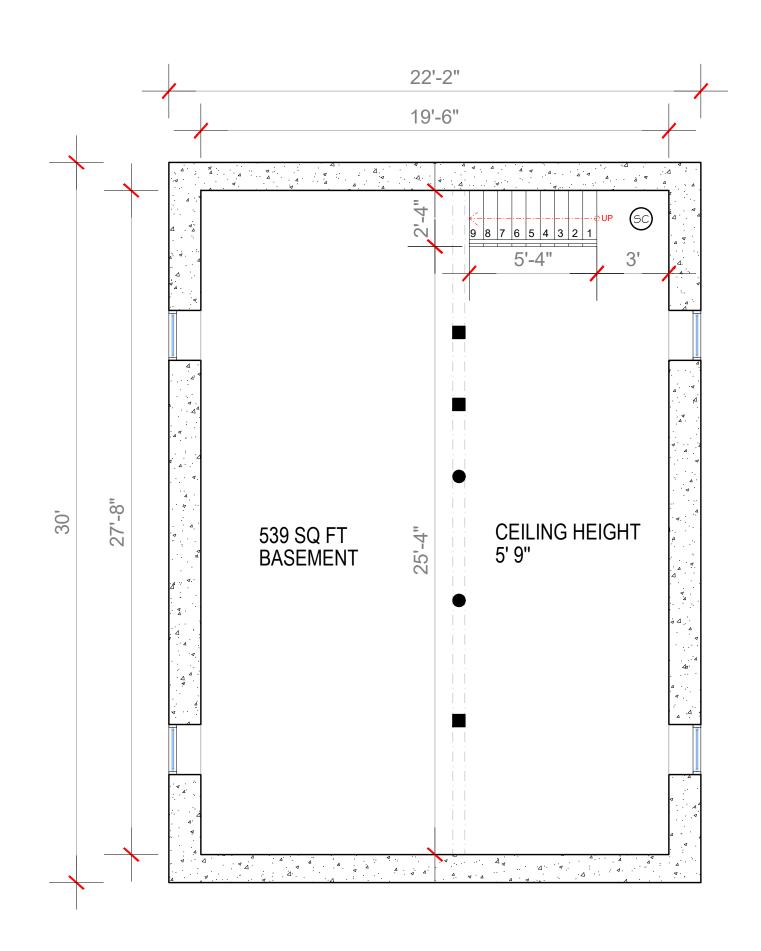

EXISTING FIRST FLOOR PLAN

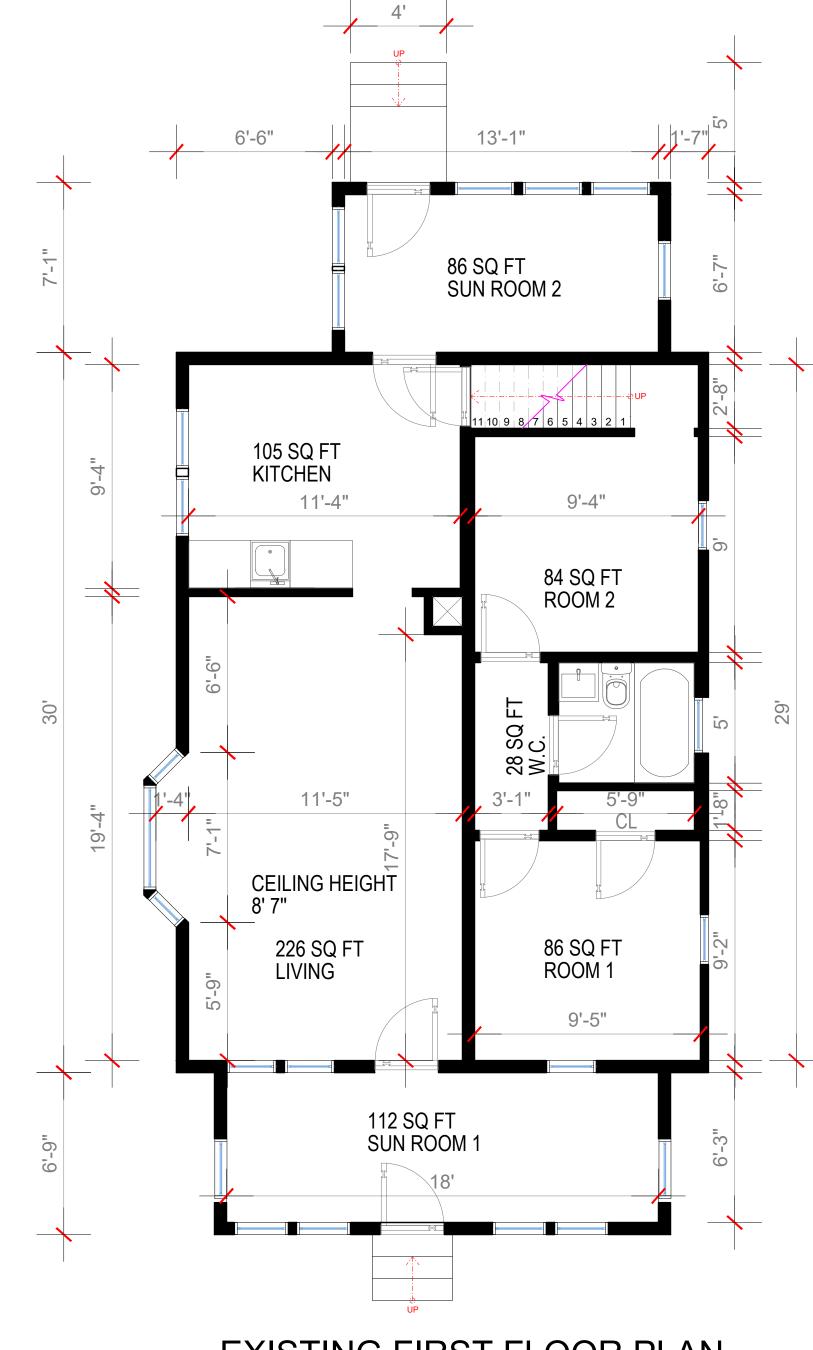1/4" = 1'0"

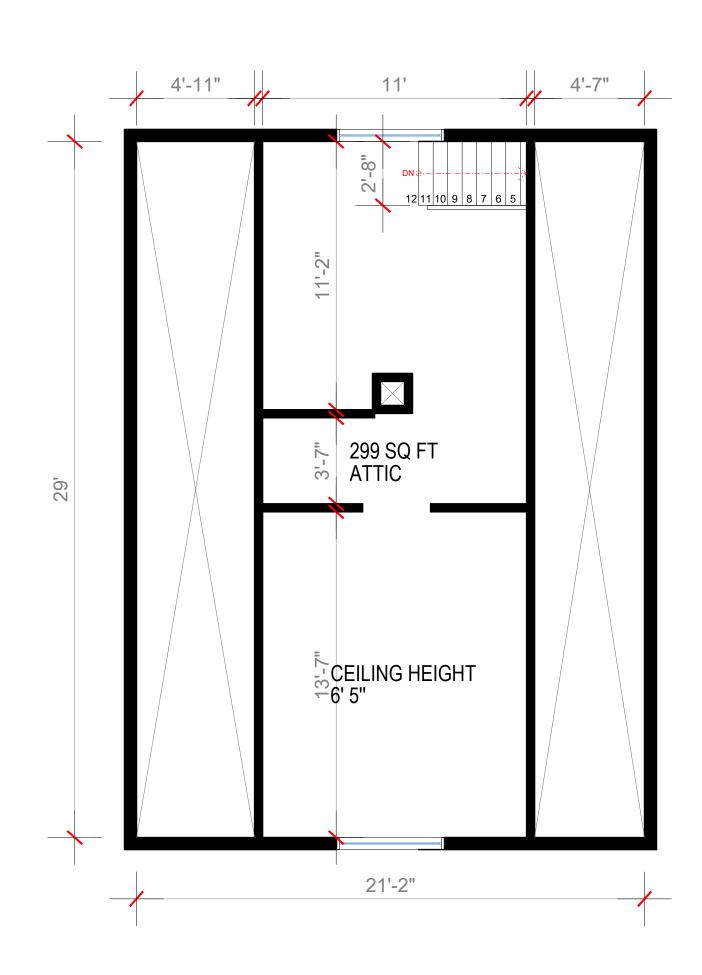

EXISTING ATTIC FLOOR PLAN.

1/4" = 1'0"

LEGEND

EXI

EXISTING FOUNDATION WALL.
EXISTING WALL.



71B CLINTON ST Malden, MA 02148 Tel: 617 318-6056

PROJECT NAME

HOUSE EXPANSION 30 GROVE ST, TOPSFIELD MA 01983

CLIENT

GIOVANI

PROJECT TEAM

Nathália Quirino 857 888-1216 Engineer Nazieh R. Hammouri. 857 312-9212

No.	Description	Date
00	Issue for Permit	05/26/2022
00	issue ioi Perriit	03/20/2022

DRAWING TITLE

EXISTING FLOOR PLAN.

DRAWING INFORMATION



May 26, 2022

DATE OF ISSUE

FLOOR PLAN

DESCRIPTION

AS INDICATED. Nathalia Quirino

SCALE DRAWN BY


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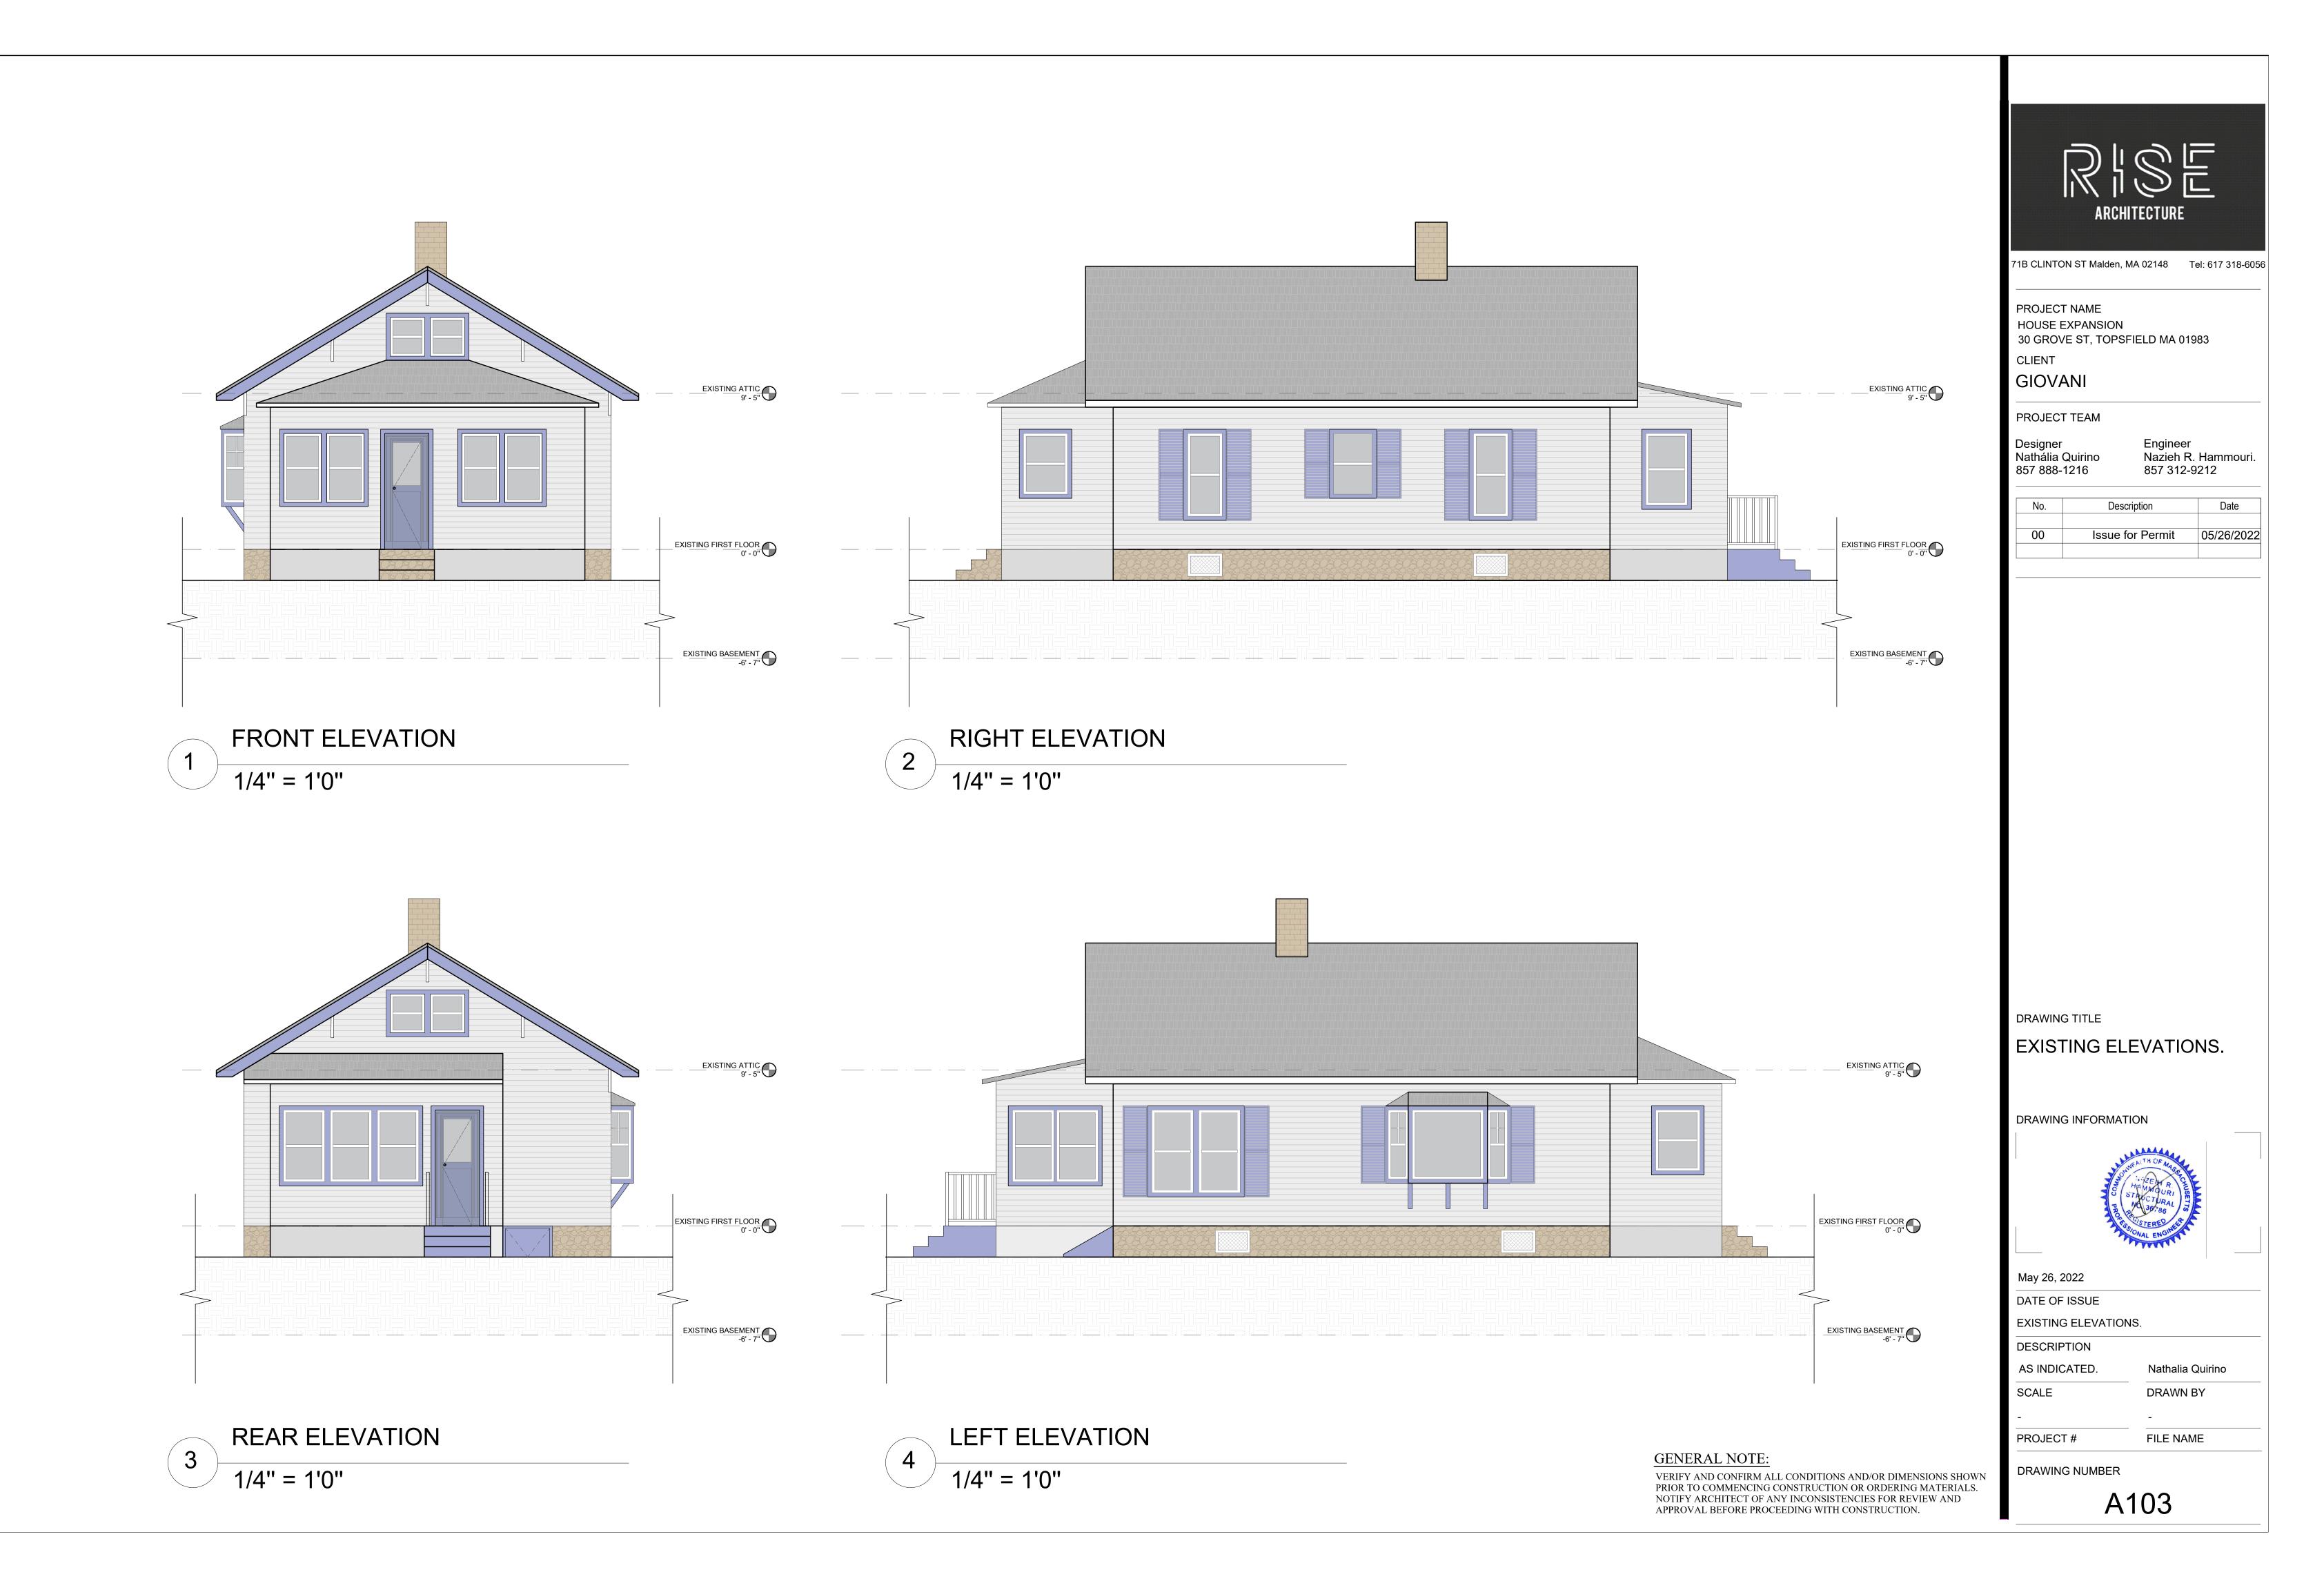
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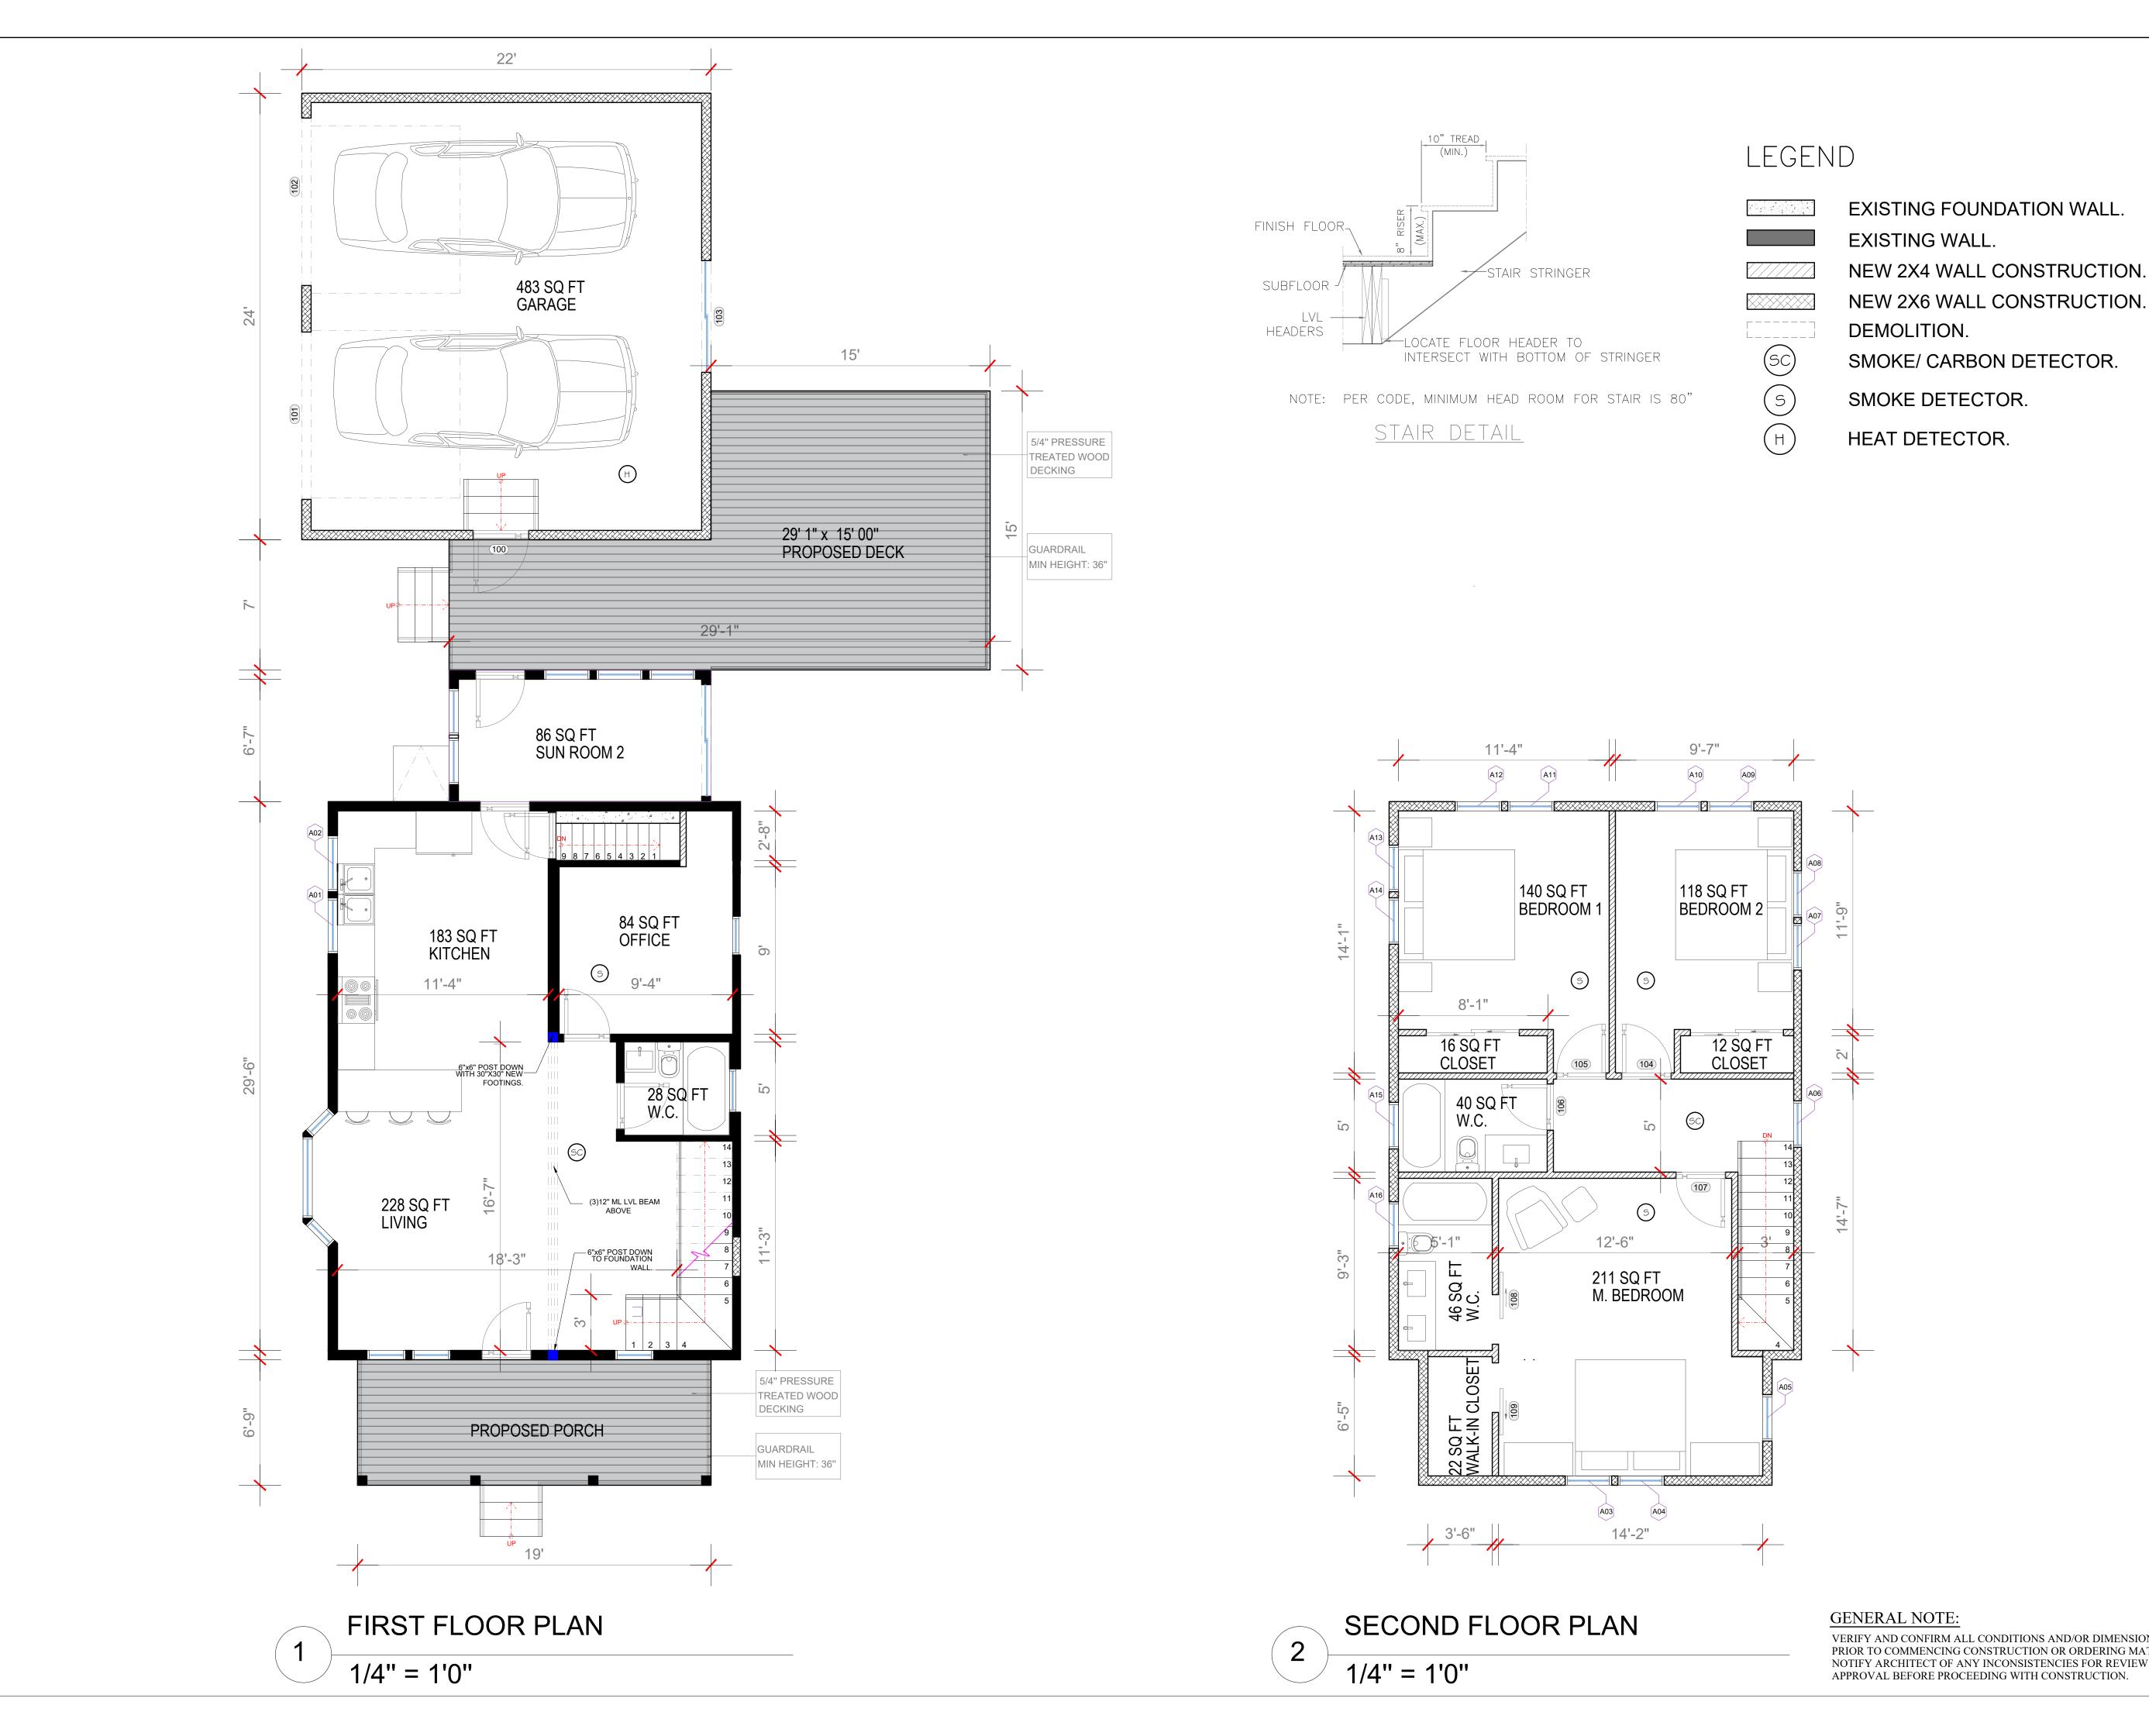
A101

GENERAL NOTE:

VERIFY AND CONFIRM ALL CONDITIONS AND/OR DIMENSIONS SHOWN PRIOR TO COMMENCING CONSTRUCTION OR ORDERING MATERIALS. NOTIFY ARCHITECT OF ANY INCONSISTENCIES FOR REVIEW AND APPROVAL BEFORE PROCEEDING WITH CONSTRUCTION.





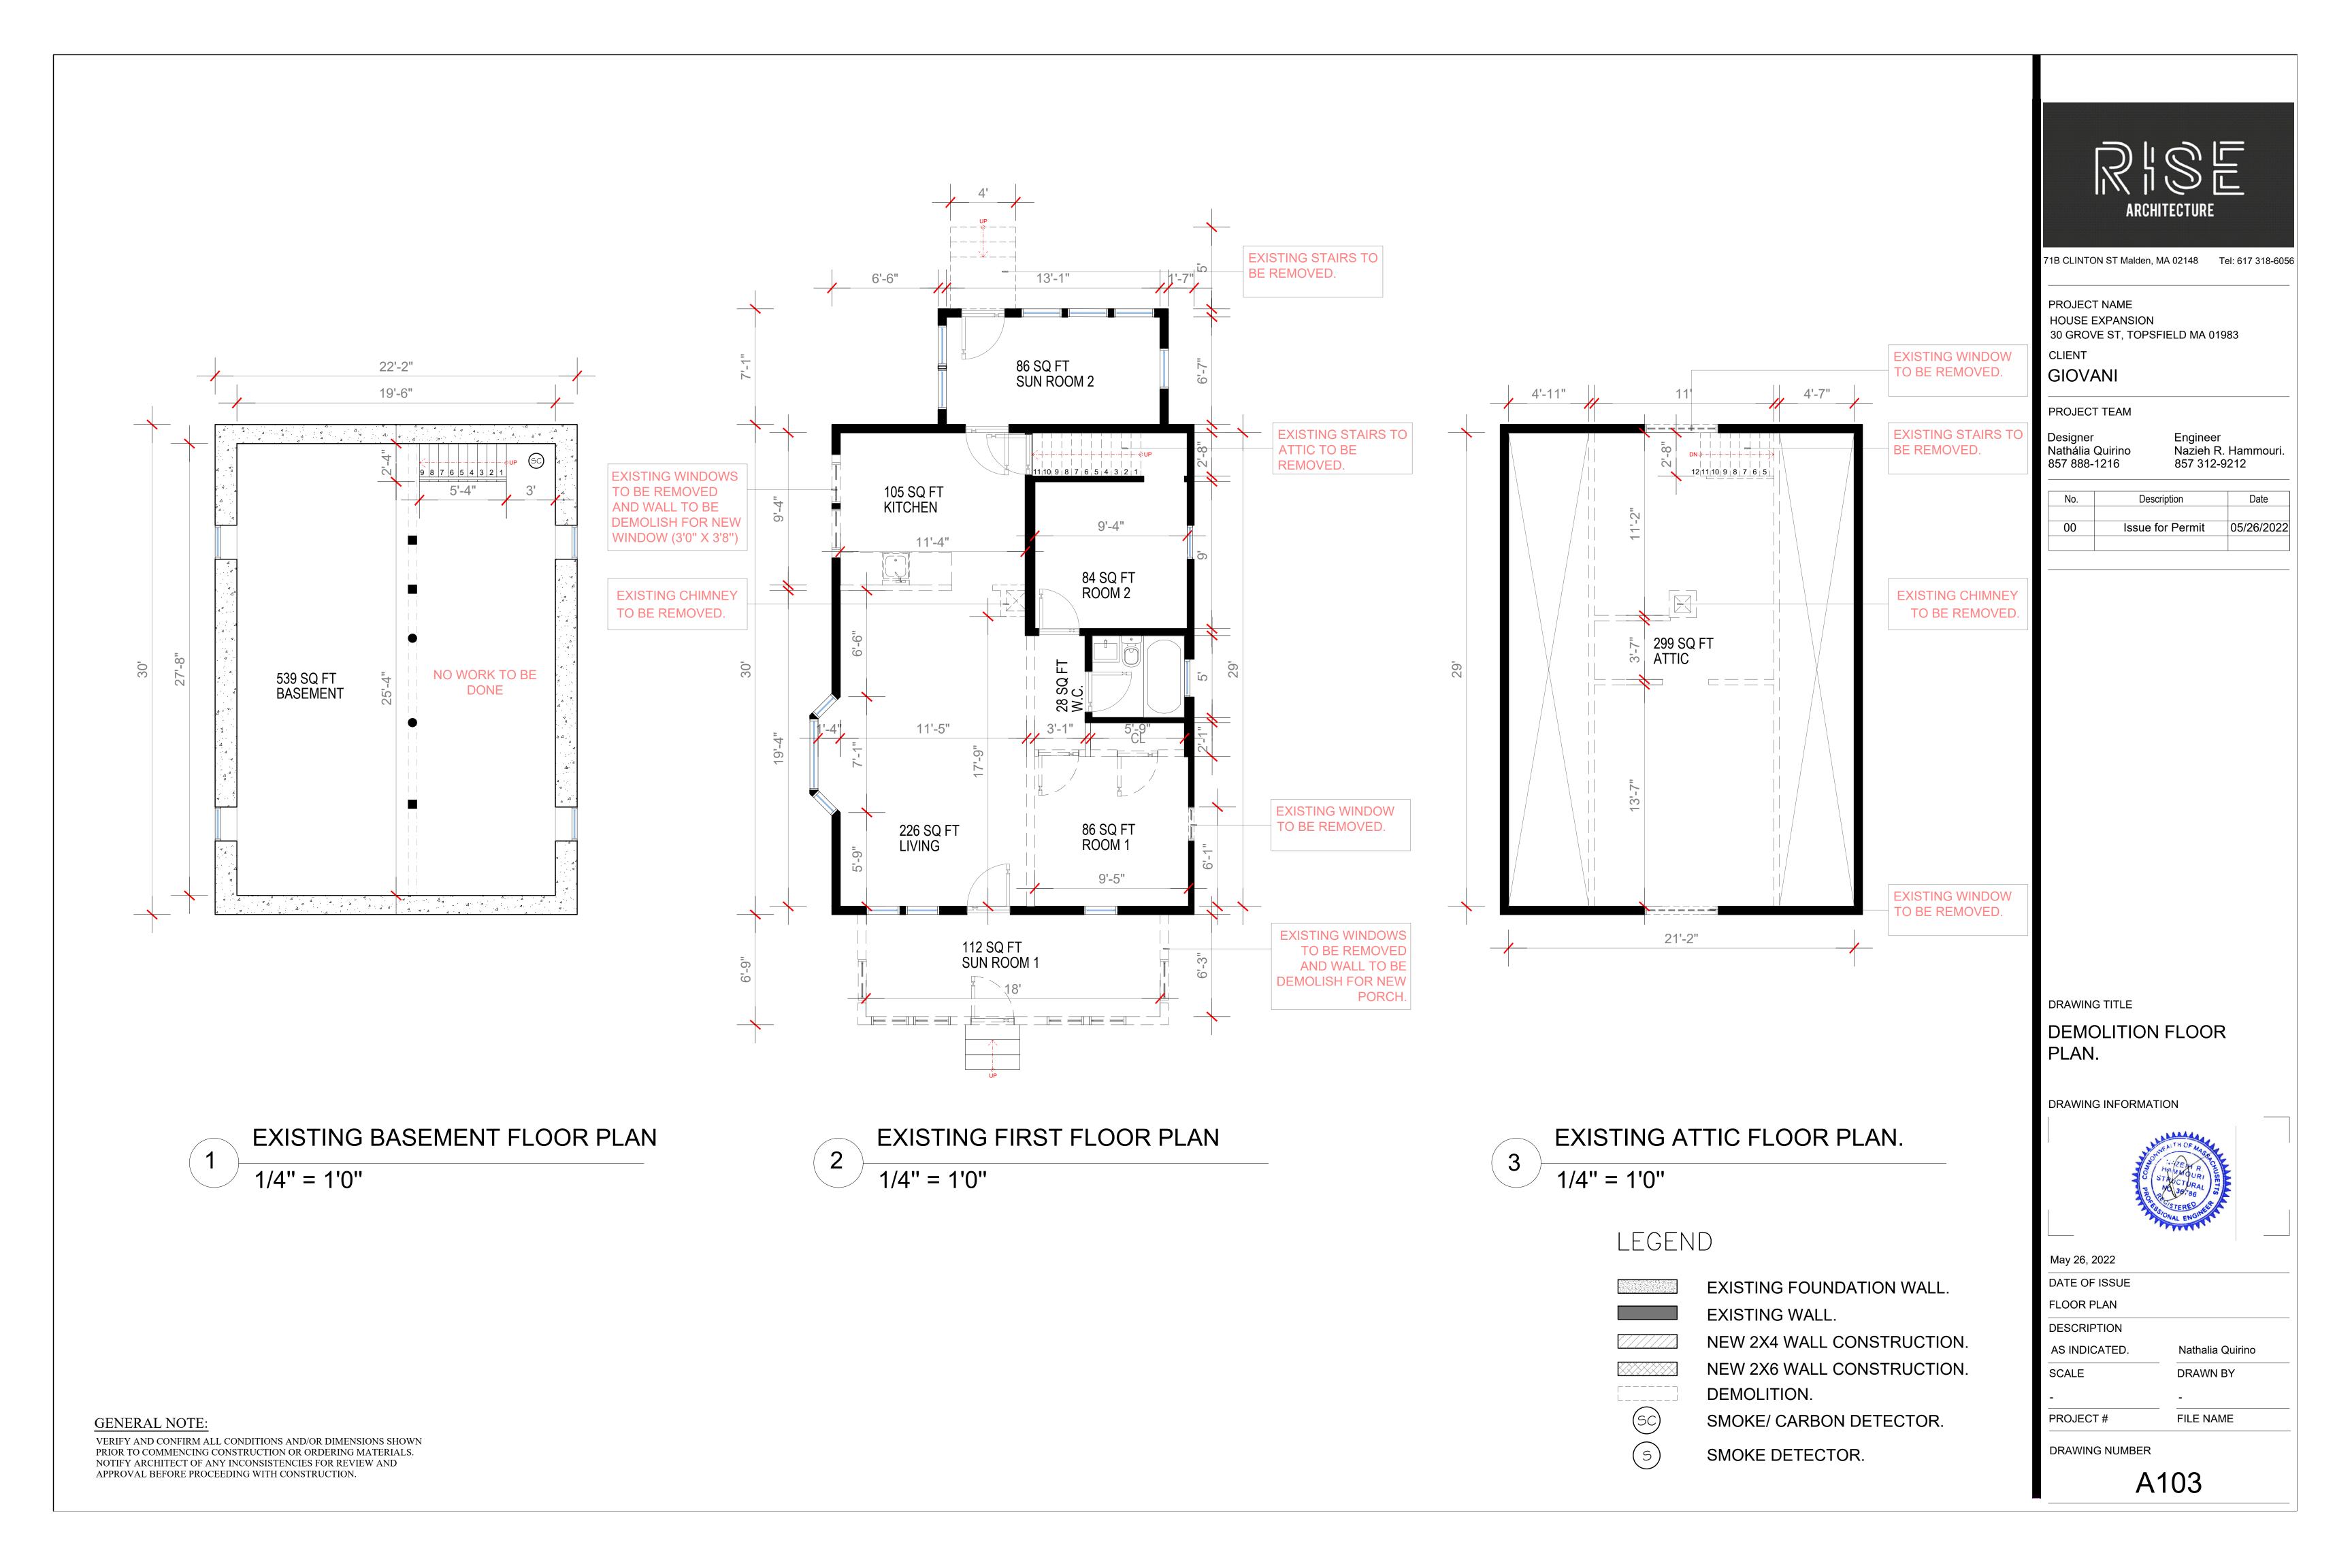

**EXISTING FOUNDATION WALL.** 

NEW 2X4 WALL CONSTRUCTION.

ARCHITECTURE

71B CLINTON ST Malden, MA 02148 Tel: 617 318-6056

PROJECT NAME **HOUSE EXPANSION** 30 GROVE ST, TOPSFIELD MA 01983 CLIENT

PROJECT TEAM

GIOVANI

Nathália Quirino

857 888-1216

Engineer Nazieh R. Hammouri. 857 312-9212

Description Date Issue for Permit 05/26/2022

DRAWING TITLE

PROPOSED FLOOR PLAN.

DRAWING INFORMATION



May 26, 2022 DATE OF ISSUE FLOOR PLAN DESCRIPTION AS INDICATED. Nathalia Quirino SCALE DRAWN BY


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PROJECT#

A104

FILE NAME

VERIFY AND CONFIRM ALL CONDITIONS AND/OR DIMENSIONS SHOWN PRIOR TO COMMENCING CONSTRUCTION OR ORDERING MATERIALS. NOTIFY ARCHITECT OF ANY INCONSISTENCIES FOR REVIEW AND



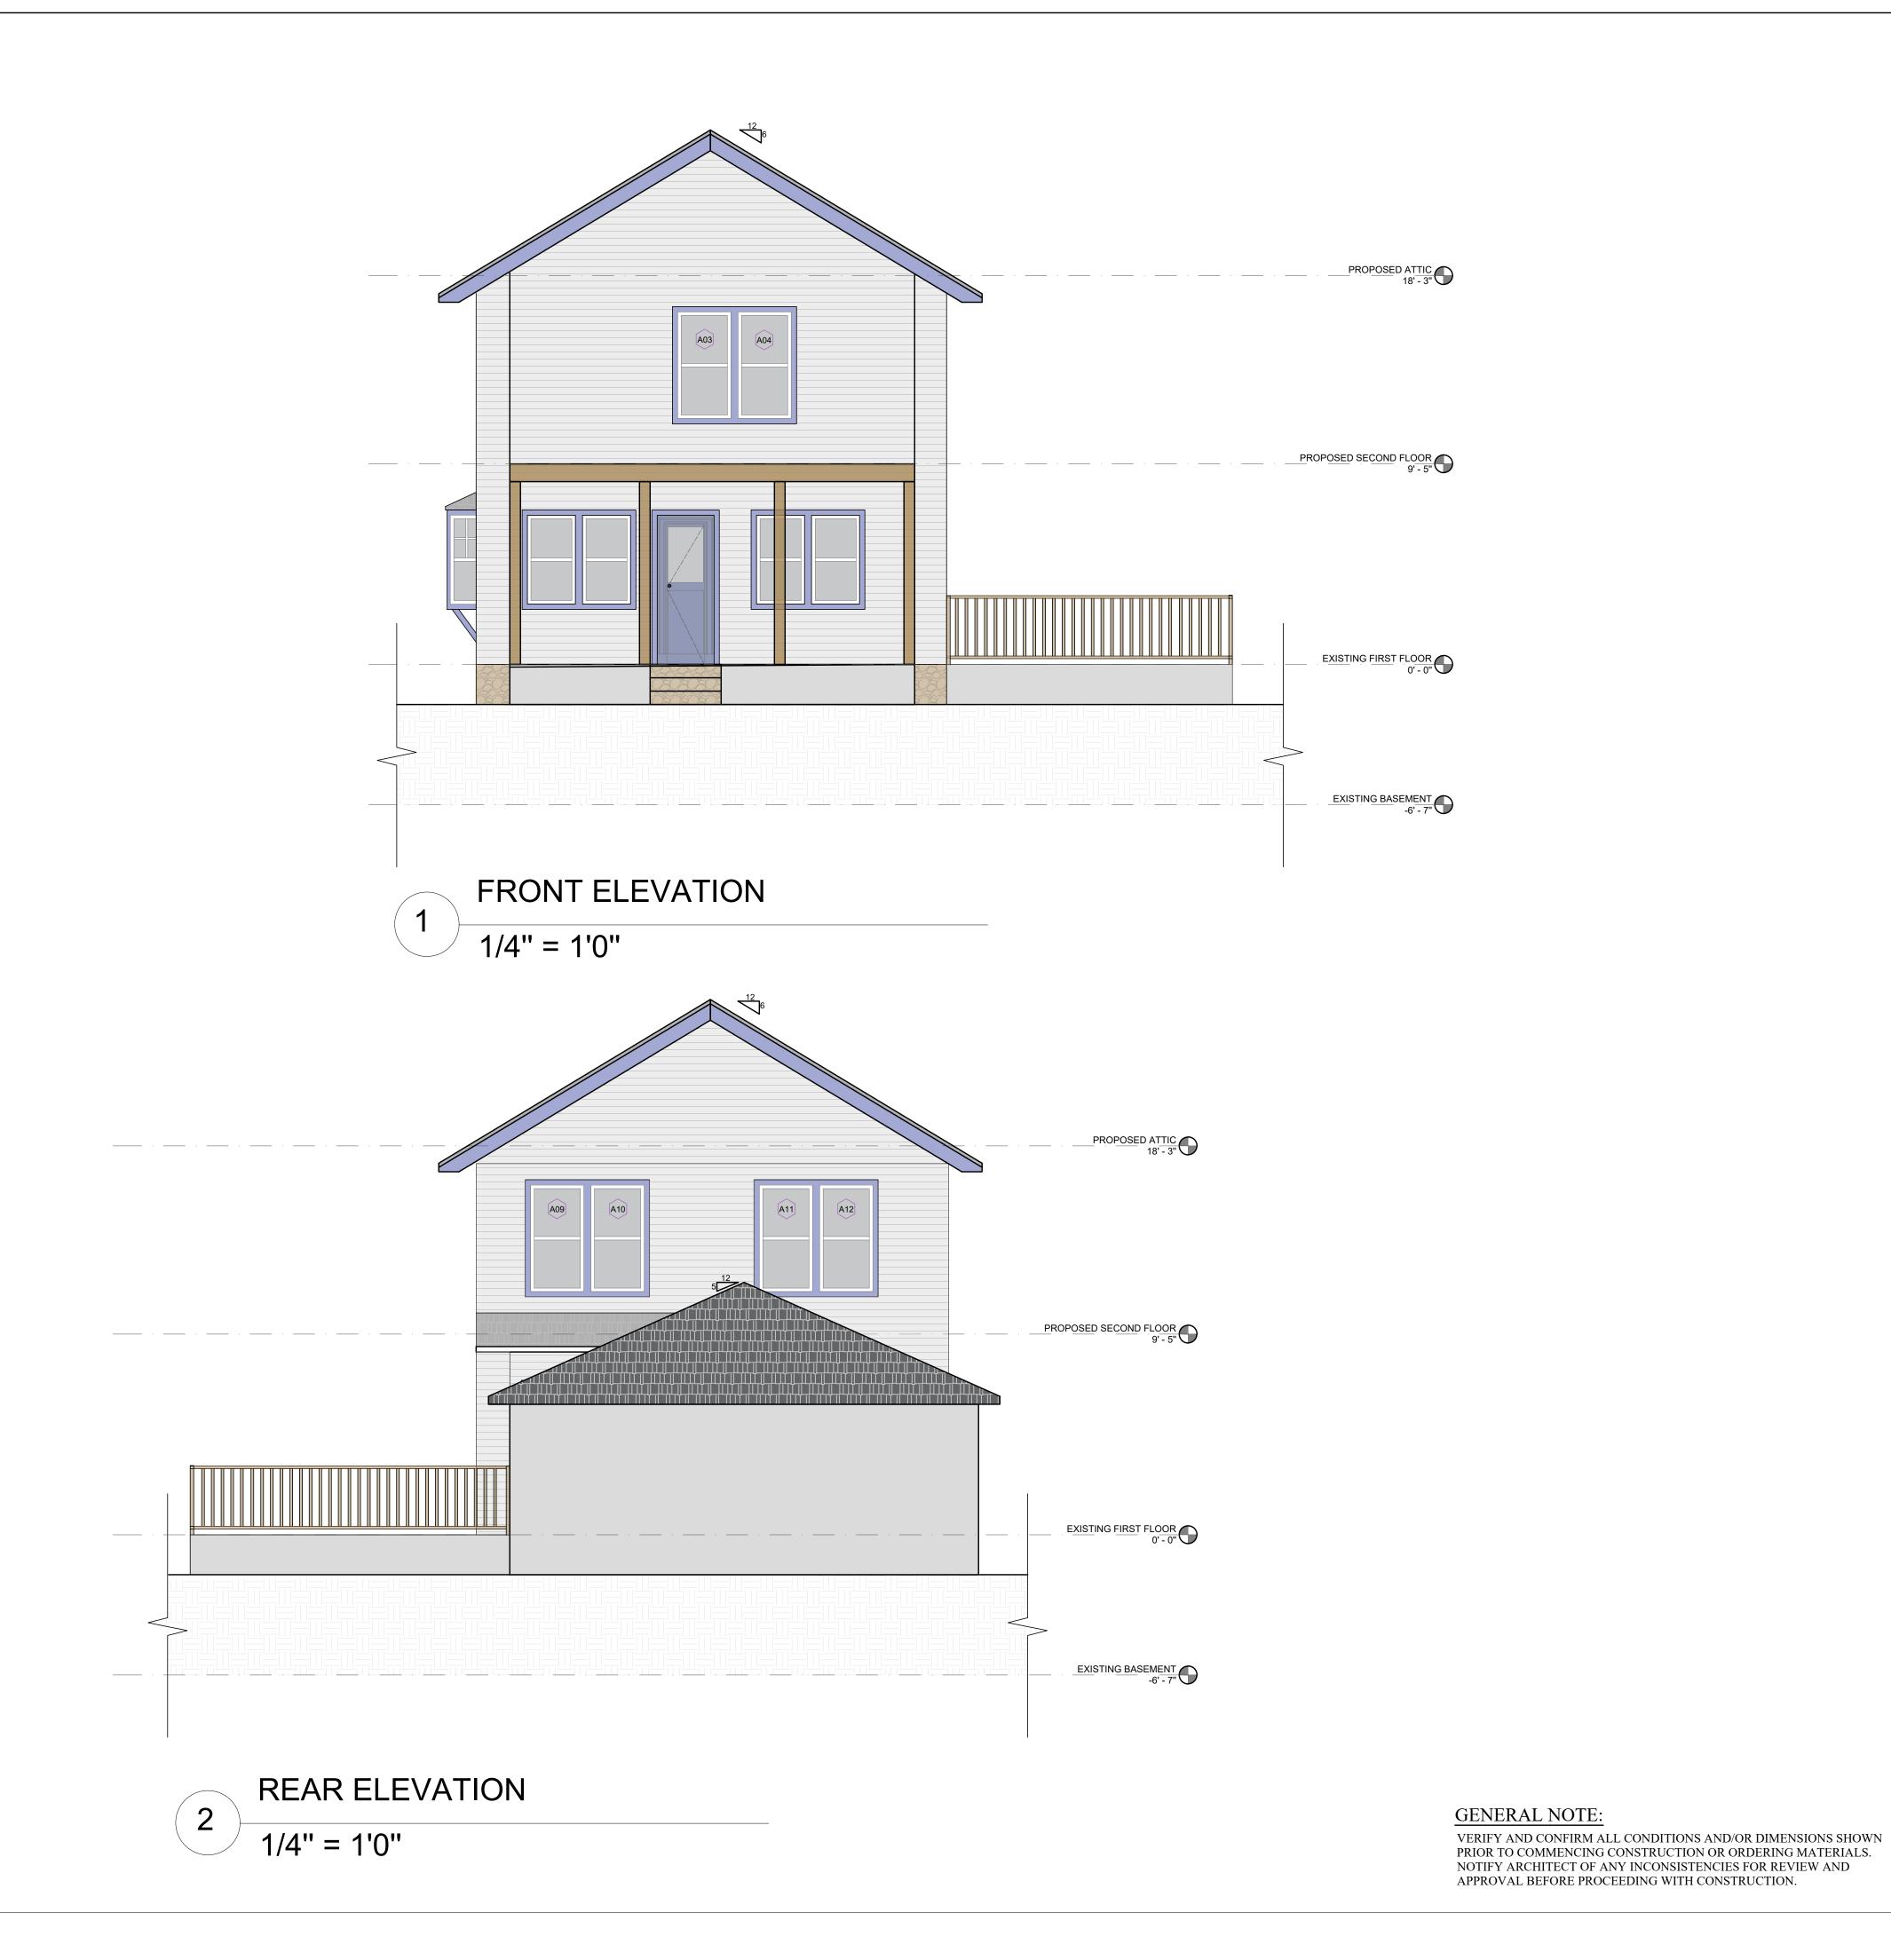

71B CLINTON ST Malden, MA 02148 Tel: 617 318-6056

PROJECT NAME HOUSE EXPANSION

30 GROVE ST, TOPSFIELD MA 01983

CLIENT GIOVANI

PROJECT TEAM

Nathália Quirino 857 888-1216 Engineer Nazieh R. Hammouri. 857 312-9212

No. Description		Date
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PROPOSED ELEVATIONS.

DRAWING INFORMATION



May 26, 2022

DATE OF ISSUE

PROPOSED ELEVATIONS.

DESCRIPTION

AS INDICATED. Nathalia Quirino

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PROJECT#

DRAWING NUMBER

**A40** 

A105

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FILE NAME



71B CLINTON ST Malden, MA 02148 Tel: 617 318-6056

30 GROVE ST, TOPSFIELD MA 01983

Engineer Nazieh R. Hammouri. 857 312-9212

No.	Description	Date
00	1	05/00/0000
00	Issue for Permit	05/26/2022



Nathalia Quirino DRAWN BY

FILE NAME

A106

# WINDOW SCHEDULE


			WINDOW			
NO.	ROOM NAME	WIDTH	HEIGHT	THICKNESS	TYPE	FINISH
A01 - A02	KITCHEN	3' - 0"	3' - 8"		TYPE A	
A03 - A14	BEDROOM	2' - 6"	5' - 0"		TYPE B	
A15 - A16	BATHROOM	2' - 6"	3' - 8"		TYPE C	



# DOOR/WINDOW FRAME 2-2x8 TOP PLATE OR PER STUDS OR PER S

# DOOR SCHEDULE

				[	DOOR		
NO.	DOOR TYPE	WIDTH	HEIGHT	THICKNESS	MATERIAL	FINISH	TYPE
100	SINGLE EXTERIOR	3' - 0"	7' - 0"				TYPE A
101 - 102	GARAGE DOOR	9' - 0"	7' - 0"				TYPE B
103	SLIDING DOOR	6' - 0"	7' - 0"				TYPE C
104 - 105 - 107	SINGLE INTERIOR	2' - 8"	7' - 0"				TYPE D
106	SINGLE INTERIOR	2' - 6"	7' - 0"				TYPE E
108 - 109	POCKET DOOR	2' - 6"	7' - 0"				TYPE F

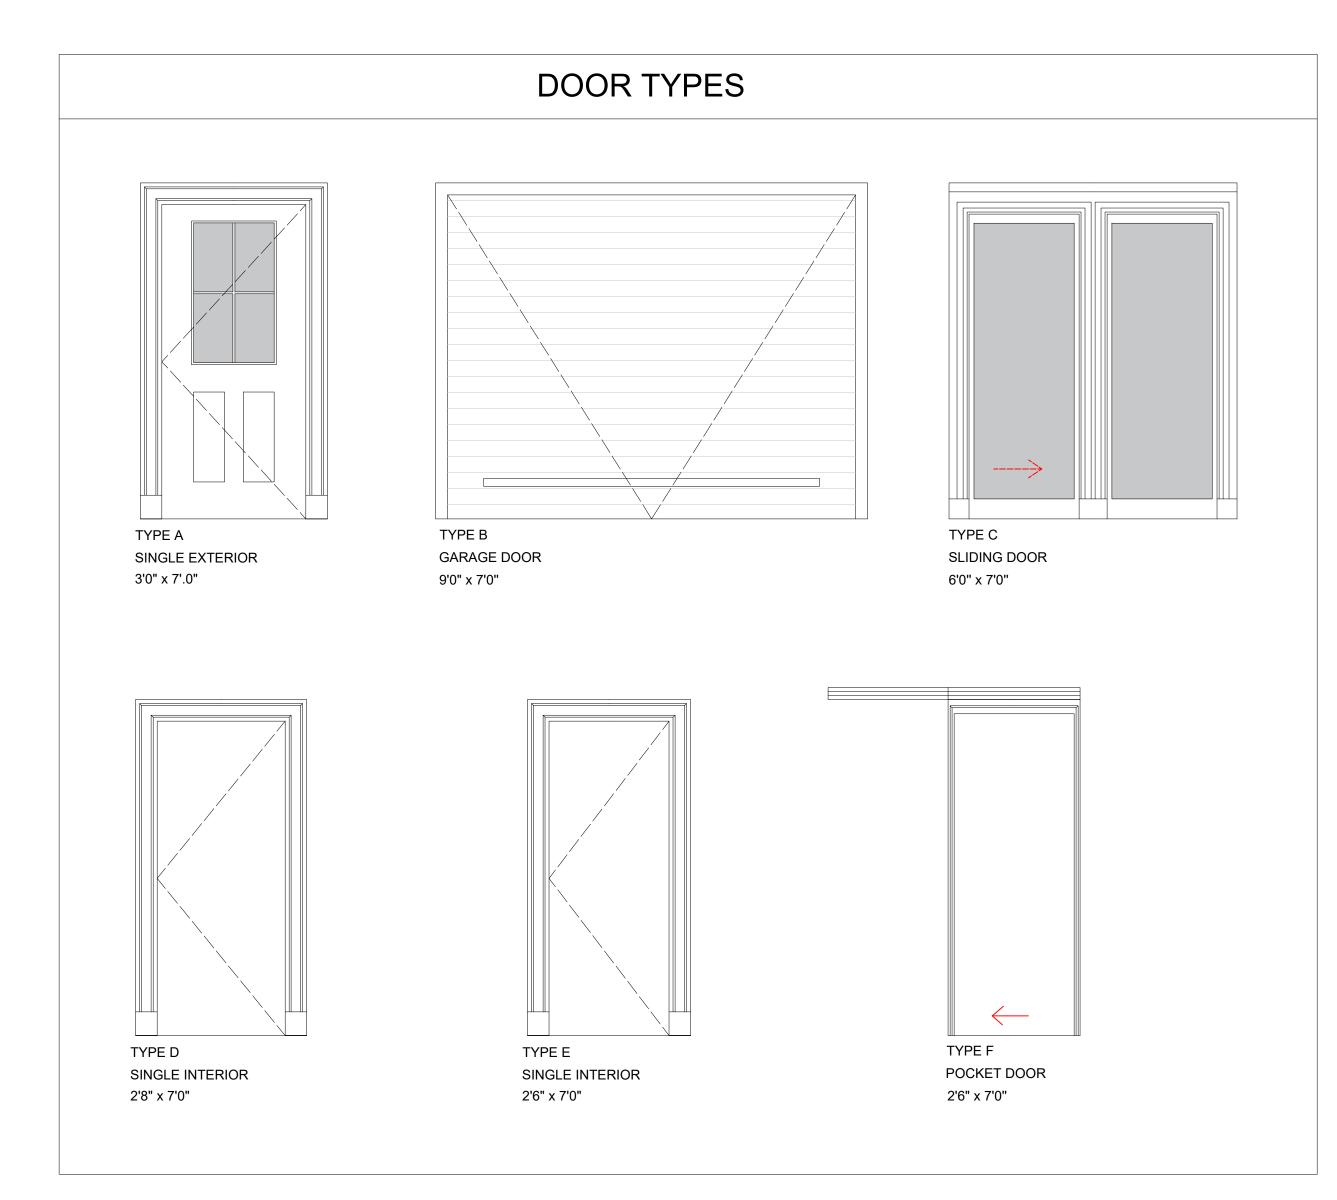



71B CLINTON ST Malden, MA 02148 Tel: 617 318-6056

PROJECT NAME HOUSE EXPANSION

30 GROVE ST, TOPSFIELD MA 01983

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PROJECT TEAM

Designer Nathália Quirino 857 888-1216 Engineer Nazieh R. Hammouri. 857 312-9212

No.	Description	Date
00	Issue for Permit	05/26/2022

DRAWING TITLE

DOOR & WINDOW SCHEDULE.

DRAWING INFORMATION



May 26, 2022

DATE OF ISSUE

DOOR & WINDOW SCHEDULE.

DESCRIPTION  $\frac{1}{2}$ " = 1'0"

SCALE

Nathalia Quirino

DRAWN BY

PROJECT # FILE NAME

DRAWING NUMBER

A107

# STRUCTURAL GENERAL NOTES

### **GENERAL**

REFER TO ARCHITECTURAL DRAWINGS FOR DIMENSIONS AND COORDINATE WITH EXISTING CONDITIONS AND FIELD MEASUREMENTS.

### **DESIGN LOADS**

LIVE LOADS

RESIDENTIAL: 40 PSF

SNOW LOADS

**GROUND SNOW PG: 40 PSF** FLAT ROOF SNOW LOAD PF: 30 PSF

### FOUNDATIONS AND EXCAVATIONS

- REMOVE ALL SOFT, ORGANIC OR OTHER UNSUITABLE MATERIAL FROM UNDER AND ADJACENT TO ALL FOOTINGS.
- 2. ALL FOOTINGS SHALL BEAR ON UNDISTURBED NATURAL SOIL HAVING A MINIMUM BEARING CAPACITY OF TWO TONS PER SQUARE FOOT.
- 3. ALL EXTERIOR FOOTINGS SHALL BE CARRIED DOWN A MINIMUM OF FOUR FEET BELOW FINISHED EXTERIOR GRADE.
- 4. MATERIAL ADJACENT TO AND BELOW FOOTINGS AND SLABS SHALL BE KEPT FROM FREEZING AT ALL TIMES. ANY FROZEN MATERIAL SHALL BE REMOVED AND REPLACED WITH CONCRETE OR COMPACTED GRAVEL.
- 5. PUMP EXCAVATION TO REMOVE SURFACE AND GROUND WATER TO PERMIT FINISHING OF EXCAVATION AND PLACEMENT OF FOUNDATIONS IN THE DRY. NO FOOTING SHALL BE PLACED IN WATER.

### **CAST-IN-PLACE CONCRETE**

- 1. ALL CONCRETE SHALL ATTAIN A MINIMUM 28 DAY COMPRESSIVE STRENGTH OF 4,000 PSI.
- PROVIDE SIX PERCENT (PLUS/MINUS) AIR ENTRAINMENT IN ALL CONCRETE EXPOSED TO EARTH OR WEATHER.
- REINFORCING STEEL SHALL CONFORM TO ASTM A615 GRADE 60.
- PROVIDE 3-#5 BARS IN EACH DIRECTION IN THE BOTTOM OF NEW COLUMN FOOTINGS.
- SEE PLANS AND SECTIONS FOR TYPICAL FOUNDATION WALL REINFORCEMENT. VERTICAL BARS SHALL BE DOWELED INTO FOOTING.
- WELDED WIRE FABRIC SHALL CONFORM TO ASTM A1064.
- 7. NEW SLAB ON GRADE SHALL BE 4" THICK. PLACED OVER A MINIMUM INSULATION AND VAPOR BARRIER.
- 8. REINFORCE SLAB ON GRADE WITH 6X6 W2.0XW2.0 WELDED WIRE FABRIC ON TOP OF SLAB, LAPPED 12" AT SIDES AND ENDS.

9. CLEARANCE OF REINFORCING BARS FROM CONCRETE SURFACES SHALL BE AS FOLLOWS:

> BOTTOM OF FOOTINGS: 3" **ALL OTHER CONDITIONS: 2"**

10. PROVIDE 5/8" DIAMETER ANCHOR BOLTS, 9" LONG, AT 32" O.C. ON TOP OF ALL FOUNDATION WALLS.

### STRUCTURAL STEEL

- STRUCTURAL STEEL TUBE COLUMNS SHALL CONFORM TO ASTM A500 15. GRADE B.
- PROVIDE 1/2"X6"X9" THICK CAP AND BASEPLATES WITH (2) 3/4" DIAMETER ANCHOR RODS TO FOOTING OR FOUNDATION, AND (2) 3/8"X4" LAG SCREWS TO BOTTOM OF NEW OR EXISTING WOOD BEAM ABOVE.
- 3. OTHER STRUCTURAL STEEL SHAPES SHALL CONFORM TO ASTM A36.

### WOOD FRAMING

- 1. ALL WOOD MEMBERS SHALL BE NEW MATERIAL. WITH A GRADE STAMP FROM THE ASSOCIATIONS HAVING JURISDICTION WHICH INDICATES SPECIES, GRADE, MILL NUMBER, MOISTURE CONTENT WHEN SURFACED OR STRESS RATING.
- 2. ALL WOOD MEMBERS SHALL BE SURFACED DRY WITH A MAXIMUM MOISTURE CONTENT OF 19% AT TIME OF DRESSING. WOOD STUDS SHALL BE KILN-DRIED.
- 3. NEW DIMENSION LUMBER FOR JOISTS, RAFTERS, AND STUDS IN BEARING AND EXTERIOR WALLS SHALL BE HEM-FIR NO. 2 OR SPRUCE- PINE-FIR NO.1/NO.2.
- 4. ALL LUMBER EXPOSED TO WEATHER, IN CONTACT WITH CONCRETE OR MASONRY, AND AS NOTED ON THE DRAWINGS, SHALL BE PRESSURE TREATED WITH WOOD PRESERVATIVE. ALL PRESSURE TREATED WOOD MEMBERS SHALL BE SOUTHERN PINE NO. 1 OR BETTER.
- 5. WOOD STUD EXTERIOR AND BEARING WALL SHALL BE 2X6 AT 16" O.C. UNLESS NOTED OTHERWISE. WALL STUDS SHALL BE LOCATED UNDER FLOOR JOISTS OR RAFTERS.
- PROVIDE SOLID WALL BLOCKING SPACED AT 8'-0" O/C VERTICAL.
- FORM WALL CORNERS WITH A MINIMUM OF THREE STUDS SPIKED TOGETHER.
- PROVIDE SINGLE BOTTOM PLATE AND DOUBLE TOP PLATE IN ALL WALLS.
- PROVIDE VERTICAL SOLID BLOCKING AS REQUIRED AT FLOOR LEVELS TO MAINTAIN LOAD PATH UNDER ALL POSTS.
- 6" LAYER OF CRUSHED STONE. SEE ARCHITECTURAL DRAWINGS FOR 10. HEADERS FOR WOOD STUD WALL OPENINGS SHALL BE DOUBLE 2X8'S IN 2X4 WALLS AND TRIPLE 2X8'S IN 2X6 WALLS, UNLESS NOTED OTHERWISE.
  - 11. UNLESS NOTED OTHERWISE, PROVIDE DOUBLE STUDS ON EACH SIDE OF ALL OPENINGS IN BEARING WALLS. PROVIDE SINGLE KING AND SINGLE JACK AT OPENINGS FRAMED WITH 2X8'S.

- 12. UNLESS NOTED OTHERWISE, PROVIDE A MINIMUM OF TWO STUDS UNDER ALL BEAM BEARINGS. THREE STUDS UNDER TRIPLE LVL BEAMS. FOUR STUDS UNDER 4-PLY LVL BEAMS.
- 13. PROVIDE SIMPSON POST BASE AND POST CAP HARDWARE AT ALL POSTS.
- 14. ALL WOOD PANELS FOR FLOORS, ROOFS, AND WALLS SHALL BE APA RATED PLYWOOD. ALL PANELS SHALL BE INSTALLED WITH THE FACE GRAIN PERPENDICULAR TO SUPPORTS.
- FLOOR PANELS SHALL BE TONGUE AND GROOVE. 3/4" THICK. APA RATED PLYWOOD SHEATHING, EXPOSURE 1 WITH A 48/24 SPAN RATING.
- 16. NEW ROOF PANELS SHALL BE 5/8" THICK, APA RATED PLYWOOD SHEATHING, EXPOSURE 1 WITH A 48/24 SPAN RATING.
- 17. NEW SHEATHING AT EXTERIOR WALLS, WHERE APPLICABLE SHALL BE 1/2" THICK, APA RATED PLYWOOD SHEATHING, EXPOSURE 1 AT A 24 O.C. SPAN RATING, ALL PANEL EDGES SHALL BE FASTENED WITH 10d NAILS AT 4" O/C TO FRAMING AND BLOCK.
- 18. REFER TO THE MASSACHUSETTS STATE BUILDING CODE NAILING SCHEDULE FOR NAILING AND BOLTING NOT OTHERWISE SPECIFIED ON THE DRAWINGS.
- 19. PROVIDE SIMPSON HURRICANE ANCHORS AT ENDS OF ALL RAFTERS.

### **ENGINEERED WOOD PRODUCTS**

LAMINATED VENEER LUMBER (LVL) AND PARALLEL STRAND LUMBER (PSL) SHALL HAVE THE FOLLOWING MINIMUM DESIGN VALUES:

> = 2.800 PSIBENDING, Fb = 2,900 PSI (PSL ONLY) COMPRESSION, Fc = 285 PSI SHEAR. Fv MODULUS OF ELASTICITY, E = 2.000 KSI

PSL MAY BE SUBSTITUTED FOR MEMBERS SPECIFIED AS LVL.

LVL BEAMS MAY BE MADE UP OF MULTIPLE 1-3/4" OR 3-1/2" THICK PIECES. MULTIPLE LVL BEAMS SHELL BE CONNECTED TOGETHER WITH 3" LONG TIMBERLOK SCREWS AT 12" O.C. IN EACH ROW. AS FOLLOWS:

> 3½" THICK (2 PLY): 2 ROWS, ONE SIDE ONLY 51/4" THICK (3 PLY): 3 ROWS EACH SIDE 7" THICK (4 PLY): 2 ROWS EACH SIDE, 5" LONG

- INSTALL WOOD I-JOISTS IN ACCORDANCE WITH MANUFACTURER'S RECOMMENDATIONS. PROVIDE 21/2" MINIMUM BEARING AT ENDS. OR JOIST HANGERS TO BEAMS.
- 4. DO NOT NOTCH TOP OR BOTTOM CHORDS OF WOOD I-JOISTS.
- 5. WHERE JOISTS ARE FLUSH FRAMED INTO HEADER BEAMS, PROVIDE SIMPSON HANGERS.
- 6. PROVIDE SIMPSON HHUS OR HGUS BEAM HANGERS AT ALL BEAM-TO-BEAM CONNECTIONS. SEE PLANS AND DETAILS WHERE APPLICABLE FOR SPECIFIC INFORMATION.



PROJECT NAME **HOUSE EXPANSION** 30 GROVE ST. TOPSFIELD MA 01983 CLIENT

PROJECT TEAM

GIOVANI

Nathália Quirino 857 888-1216

Nazieh R. Hammouri. 857 312-9212

No.	Description	Date
00	Issue for Permit	05/26/2022

**DRAWING TITLE** 

**NOTES** 


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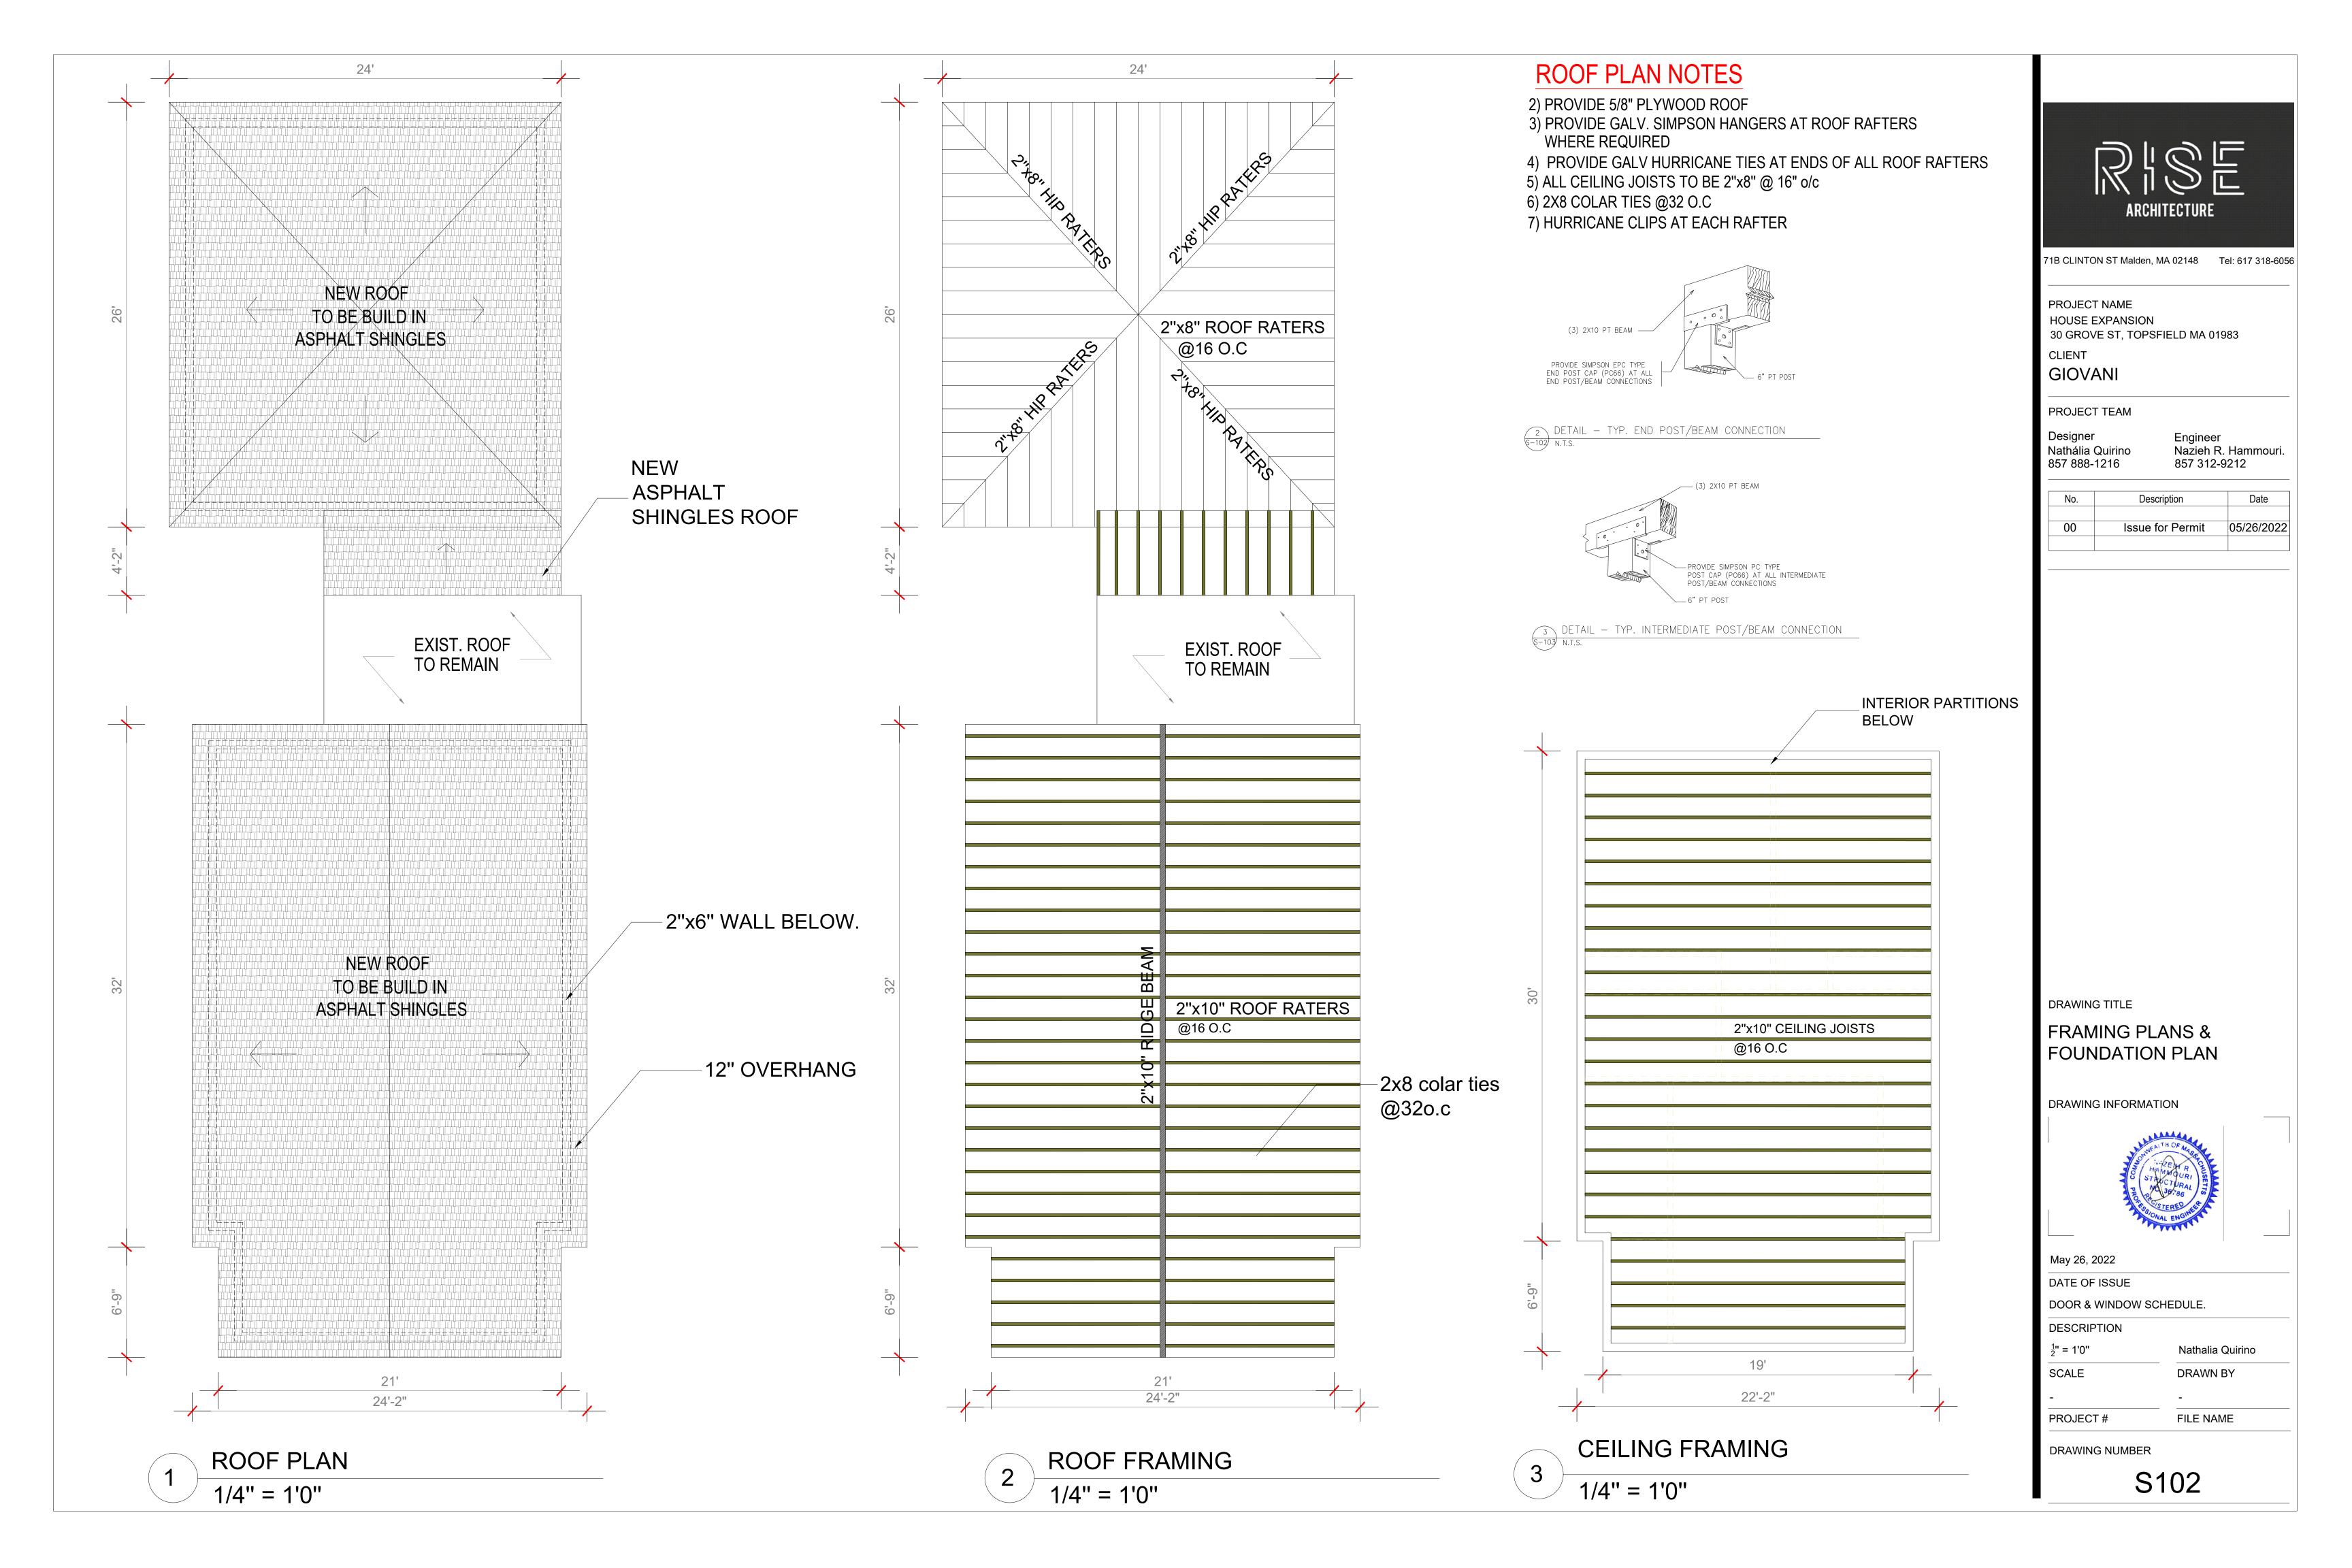


April 27, 2022 DATE OF ISSUE FLOOR PLAN. **DESCRIPTION** AS INDICATED. Nathalia Quirino SCALE **DRAWN BY** PROJECT# FILE NAME


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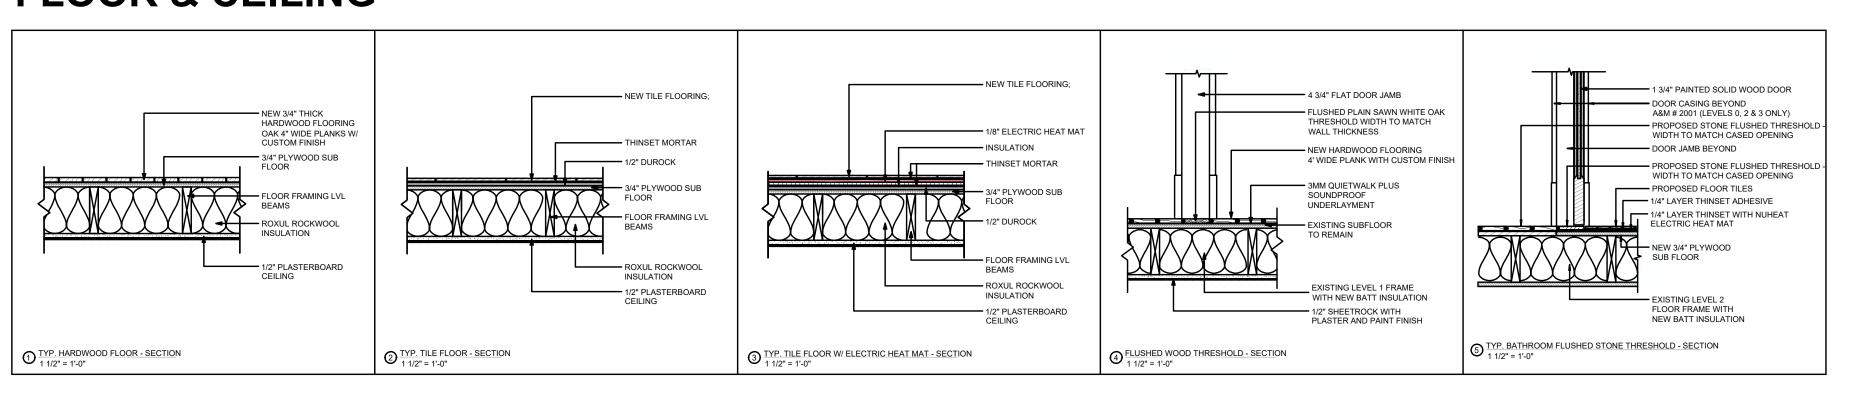




# **WALL PARTITIONS**

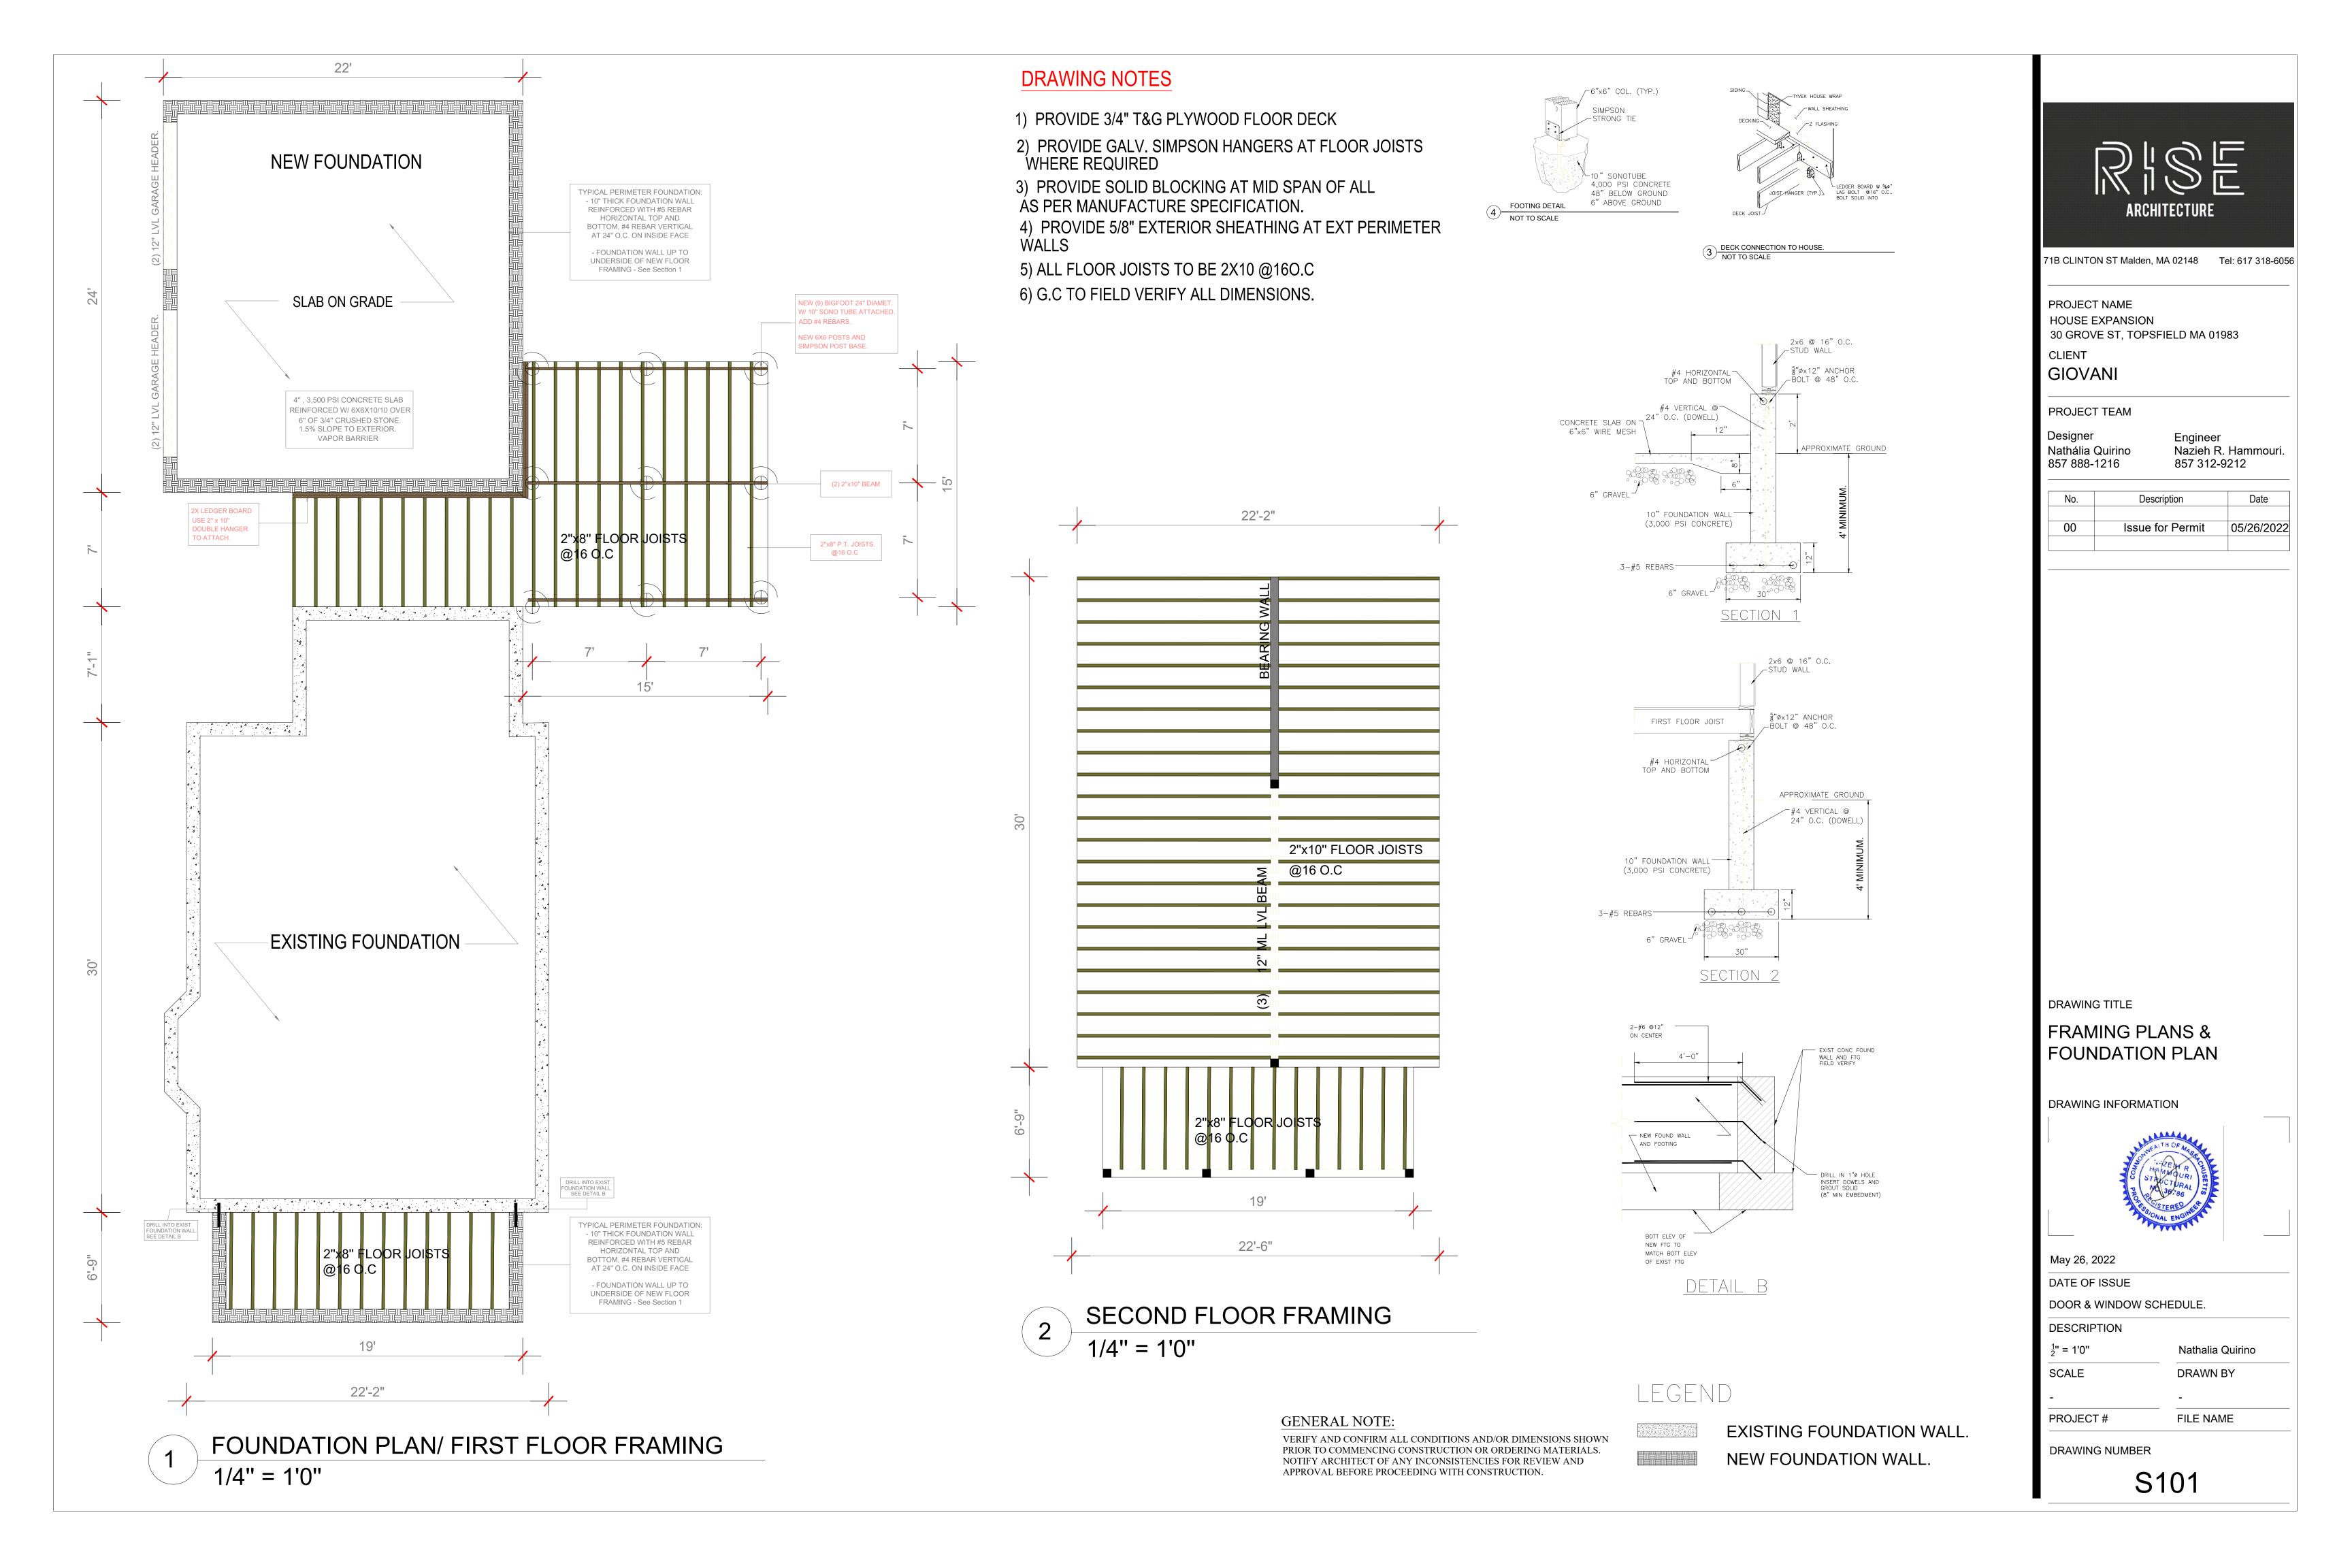

# **FLOOR & CEILING**

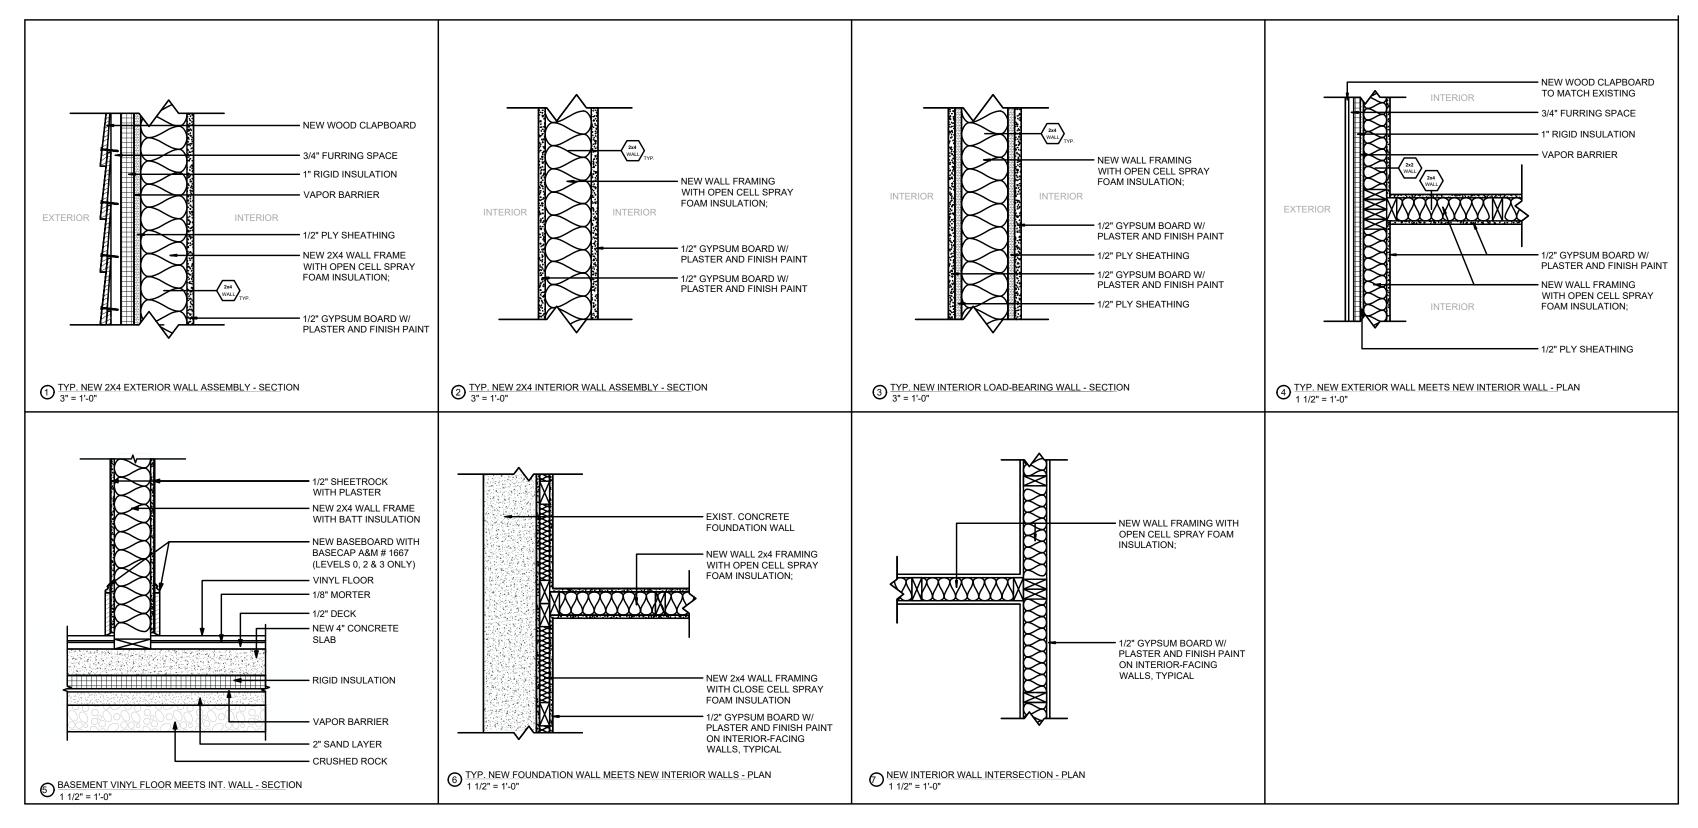



1B CLINTON ST Malden, MA 02148 Tel: 617 318-6056

PROJECT NAME
HOUSE EXPANSION
30 GROVE ST, TOPSFIELD MA 01983
CLIENT
GIOVANI

PROJECT TEAM

Designer Nathália Quirino 857 888-1216

Engineer Nazieh R. Hammouri. 857 312-9212

No.	Description	Date
00	Issue for Permit	05/26/2022

DRAWING TITLE

TYP. WALLS PARTITIONS.

DRAWING INFORMATION



April 27, 2022

DATE OF ISSUE
FLOOR PLAN.

DESCRIPTION
AS INDICATED.

Nathalia Quirino

SCALE

PROJECT #

FILE NAME

DRAWING NUMBER

S103