
303 & 333 PERKINS ROW TOPSFIELD, MASSACHUSETTS

(ASSESSOR'S MAPS 27 & 20, LOT 43)

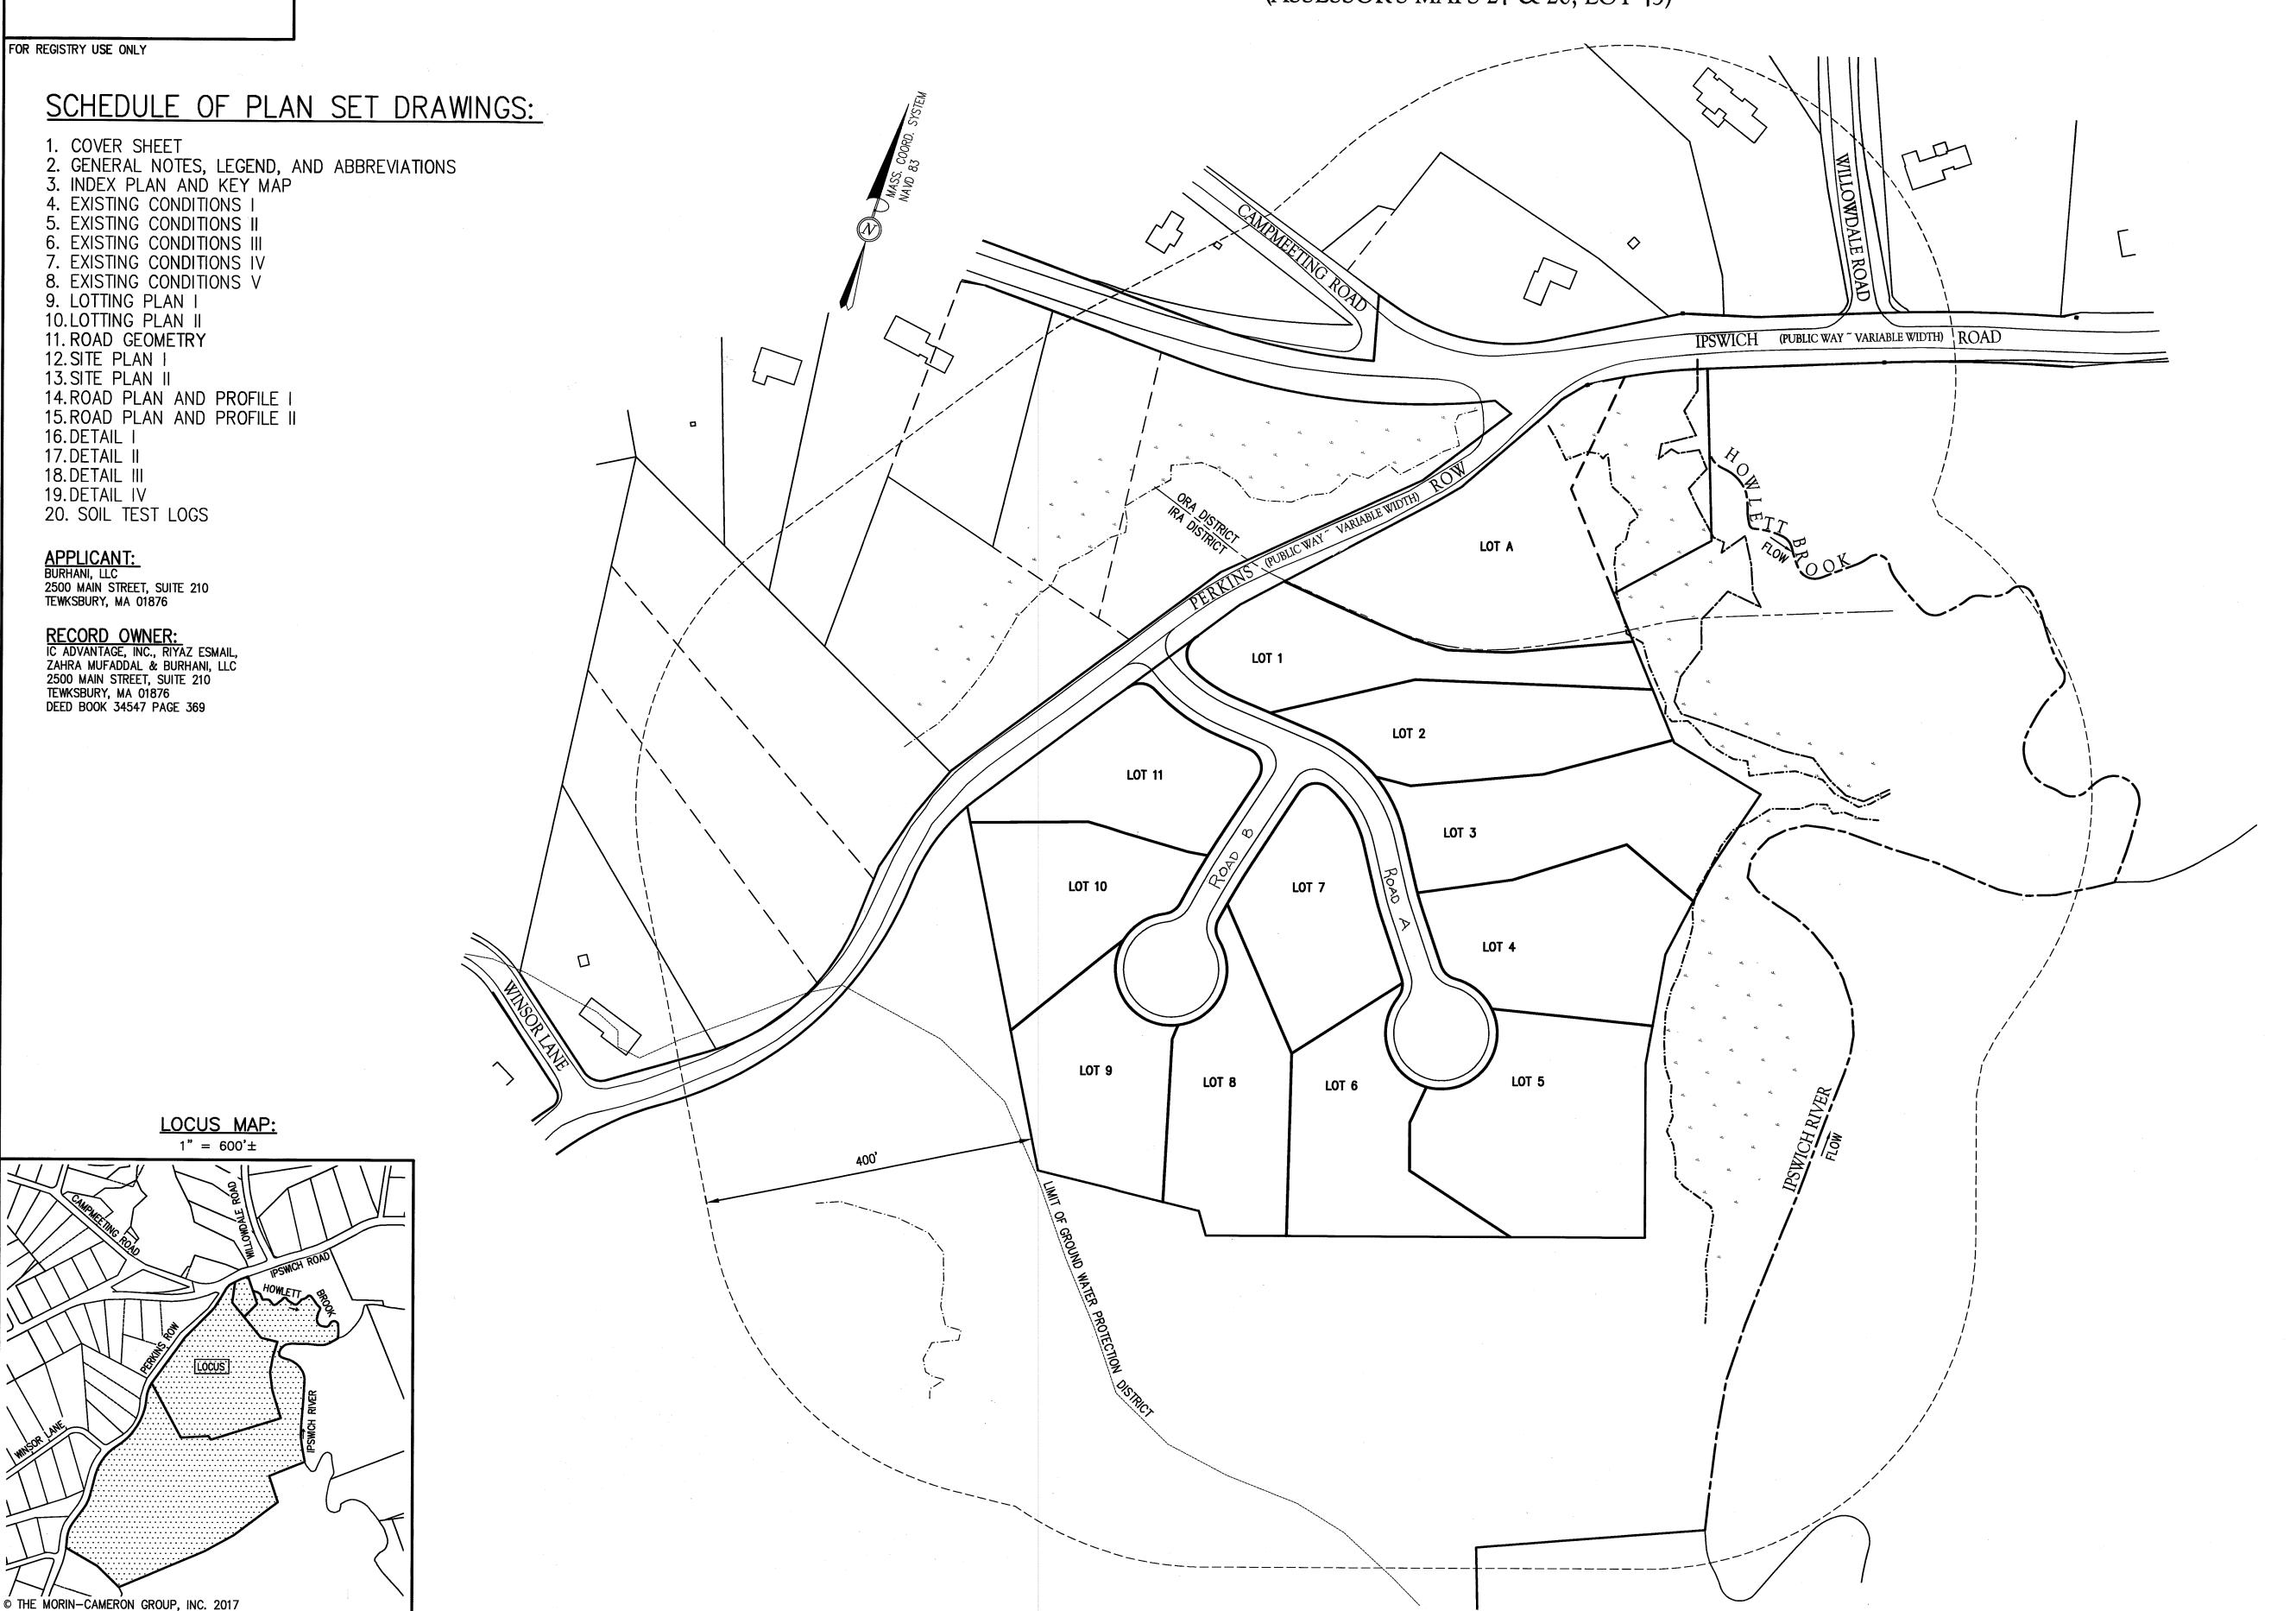

RIVERWOOD ESTATES DEFINITIVE SUBDIVISION

303 & 333 PERKINS ROW

(ASSESSOR'S MAPS 27 & 20, LOT 43) TOPSFIELD, MASSACHUSETTS

PREPARED FOR BURHANI, LLC

OCTOBER 16, 2017

SCALE: 1" = 100'

ZONING DISTRICT: INNER RESIDENTIAL AND AGRICULTURE (IRA) / OUTLYING RESIDENTIAL

AND AGRICULTURAL (ORA)

Morin-Cameron

GROUP, INC.

CIVIL ENGINEERS | ENVIRONMENTAL CONSULTANTS LAND SURVEYORS | LAND USE PLANNERS 66 ELM STREET, DANVERS, MASSACHUSETTS 01923 P: 978-777-8586, F: 978-774-3488, W: WWW.MORINCAMERON.COM

I HEREBY CERTIFY THAT THIS PLAN HAS BEEN PREPARED IN CONFORMANCE WITH THE RULES AND REGULATIONS OF THE REGISTERS OF DEEDS OF THE


/0 · /6 · /7 DATE

RECEIVED DURING THE TWENTY DAYS NET FOLLOWING SUCH RECEIPT AND RECORDING OF SAID NOTICE.

TOWN CLERK

APPROVED ON _____, SUBJECT TO

COVENANTS AND CONDITIONS EXECUTED BY _____, AND RECORDED IN THE ESSEX COUNTY REGISTRY OF DEEDS, SOUTHERN DISTRICT, BOOK No. ______, PAGE No. _____ APPROVAL UNDER THE SUBDIVISION CONTROL LAW REQUIRED DATE OF APPLICATION: OCTOBER 17, 2017 DATE OF HEARING: DATE OF APPROVAL: DATE OF ENDORSEMENT: ____

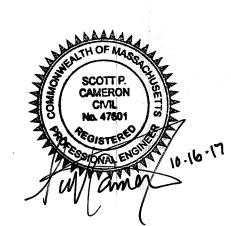

TOPSFIELD PLANNING BOARD

COVER SHEET

DRAWING NO.

1 of 20

PROJ. #3460 DRAWING: 3460 LAYOUT

FOR REGISTRY USE ONLY

LEGEND

CONTOURS MAJOR	EXISTING	PROPOSED
MINOR WATER MAIN OR SERVICE DRAIN PIPE	- 	——————————————————————————————————————
ZONE LINE PROPERTY BOUNDARY INTERIOR LOT LINE	ORIGINAL EXPERIENCES ENGINEERING SECRETARIAN SECRETARI	
SIDEWALK		
EDGE OF PAVEMENT TREE LINE		- 100
LIMIT OF BVW	· · · · · · · · - ·	
WETLAND PROTECTION DISTRICT 100' WETLAND BUFFER		
100' RIVER FRONT BUFFER	MATERIAL STATE STA	
200' RIVER FRONT BUFFER		
STONE WALL	-	
GAS LINE UNDERGROUND ELECTRIC LINE	G	—— G ——— —— UGE ——
SOIL ABSORPTION FIELD	-	
SCS SOIL BOUNDARY		
FEMA ZONE AE 10-YR FLOOD ELEVATION		
ZONE A		
FENCE		
EASEMENT		
BUILDING CATCH BASIN		
DRAIN MANHOLE		$oldsymbol{\hat{oldsymbol{ol}oldsymbol{oldsymbol{ol}oldsymbol{oldsymbol{oldsymbol{oldsymbol{oldsymbol{oldsymbol{ol}oldsymbol{oldsymbol{ol}oldsymbol{ol}oldsymbol{ol}oldsymbol{ol}}}}}}}}}}}}}}}$
FIRE HYDRANT		_
TREE		
TEST PIT	16-1	
WETLAND FLAG	<u>&</u> A11	
MEAN ANNUAL HIGHWATER MARK	_	
FLAG	15	
STONE BOUND, FOUND STONE BOUND, SET	0	
IRON ROD	Ö	
BENCH MARK	ě	

ABBREVIATI	ONS:
±	PLUS OR MINUS
APPROX.	APPROXIMATE
BK	BOOK
BVW	BORDERING VEGETATED WETLAN
CB	CONCRETE BOUND
©	CENTERLINE
D	DIAMETER
DH	DRILL HOLE
ECSB	ESSEX COUNTY STONE BOUND
EP	EDGE OF PAVEMENT
FF	FIRST FLOOR
FND	FOUND
GAR	GARAGE
IP	IRON PIPE
ÜF	LINEAR FEET
MEA	MEASURED
	NOW OR FORMERLY
	NORTH-SOUTH-EAST-WEST
N.T.S.	NOT TO SCALE
PG	PAGE
P	PROPERTY LINE
REC	RECORD
SB	STONE BOUND
S.F.	SQUARE FEET
S.A.S.	SOIL ABSORPTION FIELD
ISF	IRREGULAR SHAPE FACTOR
MAHW	MEAN ANNUAL HIGH WATER
L	LENGTH
R	RADIUS
Δ	DELTA
ORA	OUTLYING RESIDENTIAL AND
ONA	AGRICULTURAL
IRA	INNER RESIDENTIAL AND
IIVA	AGRICULTURAL
PROP.	PROPOSED
EXIST.	EXISTING
RET.	RETAINING
LA	LOT AREA
BA	BUILDABLE AREA
TYP.	TYPICAL
TBM	TEMPORARY BENCH MARK
TOF	TOP OF FOUNDATION
CLDI	CEMENT LINED DUCTILE IRON
HDPE	HIGH DENSITY POLYURETHANE
MIN.	MINIMUM
MAX. FT	MAXIMUM
	FEET
STA	STATION POINT OF VERTICAL
PVI	POINT OF VERTICAL
D\/T	INTERSECTION
PVT	POINT OF VERTICAL TANGENCY
PVC	POINT OF VERTICAL CURVATUR
ELEV.	ELEVATION

PLAN NOTES:

- 1. ELEVATIONS ARE BASED ON NAVD 1988 AS OBTAINED BY GPS TRIANGULATION.
- 2. TOPOGRAPHIC FEATURES AND LOCATIONS WERE OBTAINED FROM AN AERIAL SURVEY PERFORMED BY COL-EAST AND A PARTIAL FIELD SURVEY PERFORMED BY THE MORIN-CAMERON GROUP INC BETWEEN NOVEMBER 2016 AND APRIL 2017.
- 3. PROPERTY LINE INFORMATION WAS OBTAINED FROM A FIELD SURVEY PERFORMED BY THE MORIN-CAMERON GROUP, INC. BETWEEN THE MONTHS OF NOVEMBER 2016 AND APRIL 2017.

WETLAND NOTE:

WETLAND RESOURCE AREAS WERE FLAGGED BY DEROSA ENVIRONMENTAL CONSULTING DURING THE MONTH OF NOVEMBER 2016 AND APPROVED IN AN ORDER OF RESOURCE AREA DELINEATION DATED MAY 11, 2017, DEP FILE #307-0752.

FLOOD NOTE:

1. BY EXAMINATION OF THE CURRENTLY APPLICABLE FEMA FLOOD MAP A PORTION OF THIS PROPERTY IS LOCATED WITHIN A ZONE X (AREAS OF 0.2% ANNUAL CHANCE; AREAS OF 1% CHANCE FLOOD WITH AVERAGE DEPTHS OF LESS THAN 1 FOOT OR WITH DRAINAGE AREAS LESS THAN 1 SQUARE MILE) AS SHOWN ON THE FLOOD INSURANCE RATE MAP COMMUNITY PANEL NO. 25009C402F, 25009C404F, 25009C406F AND 25009C408F WITH AN EFFECTIVE DATE OF JULY 3, 2012.

SITE PLAN NOTES:

- 1. THE DEFINITIVE SUBDIVISION WAS DESIGNED AS A COMPREHENSIVE PLAN TAKING INTO CONSIDERATION THE DEVELOPMENT OF THE ROADWAY AND THE HOUSE LOTS.
- THE GRADING PLAN SHALL BE ADHERED TO BY THE SITE CONTRACTOR FOR THE ROADWAY CONSTRUCTION. INDIVIDUAL LOT DEVELOPMENT SHOULD ALSO CONFORM TO THE SUBDIVISION GRADING PLAN TO THE EXTENT PRACTICABLE. IF DEVIATIONS FROM THE SUBDIVISION GRADING PLAN ARE PROPOSED, THE LOT DESIGN ENGINEER SHALL TAKE PRECAUTIONS TO ENSURE THAT THE INTENT OF THE ORIGINAL DESIGN IS MET AS A RESULT OF THE VARIED PLAN.
- 2. AFTER CONSTRUCTION, AND DURING THE INITIAL VEGETATION ESTABLISHMENT PERIOD, THE SITE SHOULD BE INSPECTED AFTER EVERY RAINFALL UNTIL FULL STABILIZATION IS ACHIEVED.
- 3. SUBDRAINS SHALL BE INSTALLED WITHIN ALL CUT AREAS.
- 4. ALL HANDICAP CURB RAMPS, SIDEWALKS AND DRIVEWAY CURB CUTS SHALL COMPLY WITH 521 CMR: MASSACHUSETTS ARCHITECTURAL ACCESS BOARD REGULATIONS.

WATER SUPPLY NOTE:

1. THE PARCEL IS NOT SITUATED IN A ZONE A: SURFACE DRINKING WATER SUPPLY OR AN IWPA/ZONE II GROUNDWATER DRINKING WATER SUPPLY.

ZONING TABLES FOR CONVENTIONAL LOTS:

DIMENSIONS FOR INNER RESIDENTIAL &

AGRICULTURAL ZONING	G DISTRICT (IRA)
SETBACK	REQUIRED
AREA	40,000 S.F. (1)
FRONTAGE	150 FT. (1)
DEPTH	150 FT.
WIDTH	120 FT. AT BUILDING LINE
FRONT	20 FT.
SIDE	15 FT.
REAR	40 FT.
HEIGHT/STORIES	35 FT./2.5
MAXIMUM BUILDING AREA	25%
MINIMUM OPEN SPACE	50%

DIMENSIONS FOR OUTLYING RESIDENTIAL & AGRICULTURAL ZONING DISTRICT (ORA)

	12.14
SETBACK	REQUIRED
AREA	87,120 S.F.
FRONTAGE	200 FT.
DEPTH	200 FT.
WIDTH	160 FT. AT BUILDING LINE
FRONT	20 FT.
SIDE	20 FT.
REAR	40 FT.
HEIGHT/STORIES	35 FT./2.5
MAXIMUM BUILDING AREA	15%
MINIMUM OPEN SPACE	50%

ZONING TABLE NOTES:

- 1. REQUIREMENT PURSUANT TO TOPSFIELD ZONING BYLAW REVISED THROUGH
- 2. EACH LOT MUST FIT A 100' DIAMETER CIRCLE WHERE ONLY 10% OF THE CIRCLE IS
- WITHIN THE BUFFER ZONE TO A WETLAND RESOURCE AREA.
- 3. THE MINIMUM BUILDABLE AREA IS 30,000 SF. 4. SEE SECTION 4 OF THE TOPSFIELD ZONING BYLAW.

STORM DRAIN NOTES:

- I. STORMWATER CONVEYANCE PIPES SHALL BE HDPE, DOUBLE WALL, SMOOTH INTERIOR PIPE, CONFORMING H-20 LOADING CAPACITY UNLESS NOTED OTHERWISE.
- 2. BACKFILL SHALL BE COMPACTED TO 95% PERCENT IN ACCORDANCE WITH ASTM DESIGNATION 1557-70, METHOD D.
- 3. SHEETING, IF USED, SHALL BE REMOVED PRIOR TO BACKFILLING TRENCHES.
- 4. UNSUITABLE SOIL BELOW THE INVERT SHALL BE REMOVED AND REPLACED WITH APPROVED MATERIAL AND SHALL NOT BE USED AS BACKFILL.
- 5. UNSUITABLE MATERIALS SHALL BE REMOVED FROM BENEATH THE INFILTRATION FACILITIES AND REPLACED WITH CLEAN, GRANULAR FILL MEETING THE ASTM C33
- 6. CATCH BASIN AND DRAIN MANHOLE RIM SIZES MAY NOT BE ILLUSTRATED TO SCALE.

GENERAL UTILITY NOTES:

SPECIFICATIONS (CONCRETE SAND).

- 1. THE CONTRACTOR IS SPECIFICALLY CAUTIONED THAT THE LOCATION AND/OR ELEVATION OF EXISTING UTILITIES AND STRUCTURES AS SHOWN ON THESE PLANS IS BASED ON RECORDS OF VARIOUS UTILITY COMPANIES AND WHERE POSSIBLE. MEASUREMENTS TAKEN IN THE FIELD. THIS INFORMATION IS NOT TO BE RELIED UPON AS BEING EXACT OR COMPLETE. THE LOCATION OF ALL UNDERGROUND UTILITIES AND STRUCTURES SHALL BE VERIFIED IN THE FIELD BY THE CONTRACTOR PRIOR TO THE START OF CONSTRUCTION. THE CONTRACTOR MUST CONTACT THE APPROPRIATE UTILITY COMPANY, ANY GOVERNING PERMITTING AUTHORITY, AND "DIGSAFE" AT LEAST 72 HOURS PRIOR TO ANY EXCAVATION WORK TO REQUEST EXACT FIELD LOCATION OF UTILITIES AND THE ENGINEER SHALL BE NOTIFIED IN WRITING OF ANY UTILITIES INTERFERING WITH THE PROPOSED CONSTRUCTION AND APPROPRIATE REMEDIAL ACTION SHALL BE TAKEN BEFORE PROCEEDING WITH THE WORK. IT SHALL BE THE RESPONSIBILITY OF THE CONTRACTOR TO RELOCATE ALL EXISTING UTILITIES WHICH CONFLICT WITH THE PROPOSED IMPROVEMENTS SHOWN ON
- 2. THE CONTRACTOR SHALL BE RESPONSIBLE FOR ESTABLISHING AND MAINTAINING ALL CONTROL POINTS AND BENCHMARKS NECESSARY FOR THE WORK.
- 3. THE CONTRACTOR SHALL COORDINATE WITH THE ELECTRIC. CABLE AND TELEPHONE COMPANIES TO VERIFY THE LOCATION, SIZE AND TYPE OF SAID UTILITIES PRIOR TO CONSTRUCTION. THE CONTRACTOR SHALL GIVE SAID UTILITY COMPANIES NO LESS THAN 72 HOURS ADVANCED NOTICE OF WHEN THE UTILITY LINES WILL BE INSTALLED.
- 4. INDIVIDUAL UTILITY SERVICES FROM THE UTILITY MAIN TO THE EXTERIOR LINE OF THE R.O.W. SHALL BE CONSTRUCTED FOR EACH LOT WHETHER OR NOT THERE IS A BUILDING THEREON.
- 5. HYDRANT CONNECTIONS FOR WATER USE DURING DEMOLITION SHALL BE COORDINATED WITH THE TOPSFIELD WATER DIVISION.
- 6. COORDINATE BUILDING DEMOLITION WITH TOPSFIELD FIRE DEPARTMENT, CODE ADMINISTRATION AND BOARD OF HEALTH.

WATER AND SEPTIC NOTES:

- 1. PROPOSED WATER SERVICE CONNECTIONS SHALL BE COORDINATED WITH THE TOPSFIELD WATER DEPARTMENT AND DEPARTMENT OF PUBLIC WORKS.
- 2. ALL WATER MAINS SHALL BE INSTALLED WITH A MINIMUM OF 5' OF COVER.
- 3. INSTALL THRUST BLOCKS OR APPROVED EQUIVALENT JOINT RESTRAINTS AT ALL WATER MAIN BENDS.
- 4. AFTER COMPLETION OF THE NEW WATER MAINS AND WATER SERVICES AND BEFORE INITIAL PAVING, ALL UTILITIES SHALL BE TESTED IN THE PRESENCE OF THE TOPSFIELD WATER DEPARTMENT. ALL TESTING SHALL CONFORM TO THE TOPSFIELD WATER REGULATIONS AND SHALL BE IN COMPLIANCE WITH ASTM AND AWWA APPLICABLE REGULATIONS.
- 5. EXISTING SEPTIC SYSTEMS SHALL BE ABANDONED IN ACCORDANCE WITH 310 CMR 15: TITLE 5 STANDARD REQUIREMENTS FOR THE SITING, CONSTRUCTION, INSPECTION. UPGRADE AND EXPANSION OF ON-SITE SEWAGE TREATMENT AND DISPOSAL SYSTEMS AND FOR THE TRANSPORT AND DISPOSAL OF SEPTAGE.
- 6. SOIL ABSORPTION SYSTEM AREAS FOR PROPOSED HOUSE LOTS AREA BASED ON A SIX (6) BEDROOM DESIGN FLOW OF 660 GALLONS PER DAY (GPD) IN ACCORDANCE WITH 310 CMR 15.00: STATE SANITARY CODE TITLE 5.

ROADWAY DESIGN	<u>REQUIREMENTS</u>
REQUIREMENT	MINOR RESIDENTIAL
RIGHT-OF-WAY WIDTH	50 FT
MIN. GRADE	1%
MAX. GRADE	8%
INTERSECTION SEPARATION	125 FT
INTERSECTION RADII	25 FT
MINIMUM CENTERLINE RADII	150 FT
STOPPING SIGHT DISTANCE	200 FT
PASSING SIGHT DISTANCE	N/A

ROAD NOTES:

1. THE PROPOSED ROAD IS CONSIDERED A "MINOR RESIDENTIAL" STREET.

EROSION AND SEDIMENTATION CONTROL:

WIDELY ACCEPTED PRACTICES FOR REDUCING EROSION AND SEDIMENTATION WILL BE EMPLOYED IN THE DEVELOPMENT OF THIS SITE. REFER TO THE STORMWATER POLLUTION PREVENTION PLAN FOR THE PROJECT.

- THE DEVELOPMENT OF THE SITE HAS BEEN PLANNED TO MATCH EXISTING DRAINAGE PATTERNS TO THE EXTENT PRACTICABLE.
- 2. STEEP SLOPES, WHERE POSSIBLE, WILL NOT BE DISTURBED.
- 3. NATURAL WETLANDS WILL BE PRESERVED AND PROTECTED EXCEPT AS DETAILED HEREIN, AND EXISTING VEGETATION WILL BE RETAINED AND PROTECTED TO THE EXTENT POSSIBLE.
- 4. THE CONTRACTOR SHALL MINIMIZE THE AREA OF DISTURBED LAND TO THE EXTENT FEASIBLE.
- SEDIMENT CONTROL MEASURES WILL BE APPLIED TO CONTROL ANY SEDIMENTS THAT MAY BE PRODUCED AS A RESULT OF SITE CONSTRUCTION ACTIVITIES. EROSION AND DEPOSITION OF SEDIMENT WILL BE CLOSELY MONITORED DURING CONSTRUCTION.
- TEMPORARY EROSION CONTROL MEASURES WILL INCLUDE, BUT NOT BE LIMITED TO, FILTER FABRIC SILT FENCES, HAYBALE BARRIERS, SILT SOCKS, SEEDING AND MULCHING. SEEDED FILTER STRIPS AND SILT SACKS IN CATCH BASINS (EXISTING AND **NEWLY INSTALLED).**
- TOPSOIL STRIPPED FROM THE SITE WILL BE STOCKPILED FOR LOAMING AND SEEDING AT LATER CONSTRUCTION STAGES. THE STOCKPILES SHALL BE LOCATED SO AS TO ACT AS TEMPORARY DIVERSIONS, GENERALLY ON AN UPHILL SLOPE.
- SITE DEVELOPMENT WILL NOT COMMENCE UNTIL ALL TEMPORARY EROSION CONTROL MEASURES ARE IN PLACE. THESE MEASURES SHALL BE EMPLOYED UNTIL FINAL PAVING AND ADEQUATE VEGETATION HAS BEEN ESTABLISHED.
- 9. THE TOPSFIELD CONSERVATION COMMISSION AND DEPARTMENT OF PUBLIC WORKS SHALL BE NOTIFIED AT LEAST 48 HOURS PRIOR TO CONSTRUCTION TO INSPECT EROSION CONTROLS TO BE IMPLEMENTED DURING CONSTRUCTION.
- 10. THE CONSTRUCTION PHASE MUST COMPLY WITH THE ENVIRONMENTAL PROTECTION AGENCY (EPA) NATIONAL POLLUTANT DISCHARGE ELIMINATION SYSTEM PROTOCOLS. AN EPA NOTICE OF INTENT SHALL BE SUBMITTED TO THE EPA AT LEAST 2 WEEKS PRIOR TO THE START OF CONSTRUCTION.

CONSTRUCTION SEQUENCE:

TO PREVENT EXCESSIVE EROSION AND SILTING, THE FOLLOWING CONSTRUCTION SEQUENCE COUPLED WITH OTHER WIDELY ACCEPTED PRINCIPLES FOR REDUCING EROSION AND SEDIMENTATION SHALL BE IMPLEMENTED IN THE DEVELOPMENT OF THE SITE.

- 1. THE CONTRACTOR SHALL COORDINATE A PRE-CONSTRUCTION MEETING AT LEAST 48 HOURS PRIOR TO ANY CONSTRUCTION ACTIVITY WITH THE OWNER (OWNER'S REPRESENTATIVE). PLANNING DEPARTMENT REPRESENTATIVE AND ANY OTHER INTERESTED TOWN DEPARTMENT REPRESENTATIVES.
- STABILIZATION PRACTICES FOR EROSION AND SEDIMENT CONTROL SHALL BE INSTALLED PRIOR TO COMMENCING CONSTRUCTION ACTIVITIES. PLACE EROSION CONTROLS AT LOCATIONS INDICATED ON THE SITE DEVELOPMENT PLANS.
- CONSTRUCT STABILIZED CONSTRUCTION ENTRANCES AT THE LOCATIONS NOTED.
- 4. ALL CATCH BASINS SHALL BE PROTECTED WITH SILT SACK SEDIMENT TRAPS.
- 5. IN PREPARING TO REMOVE PAVEMENT AND MATERIALS FROM THE WORK AREA ON THE SITE, CAREFUL CONSIDERATION SHOULD BE MADE TO THE EXTENT OF DISTURBANCE SO AS NOT TO DISTURB MORE OF THE SITE THAN WHAT IS INTENDED TO BE IMMEDIATELY DEVELOPED AND RE-STABILIZED.
- LOAM AND TOP SOIL EXCAVATED FROM THE WORK AREA SHALL BE HAULED FROM THE PROPERTY AND STOCK PILED AT A LOCATION TO BE DETERMINED BY THE SITE CONTRACTOR. IF MATERIALS ARE STOCKPILED ON THE SITE WHERE THEY WILL NOT INTERFERE WITH CONSTRUCTION ACTIVITIES, THEY SHALL BE LOCATED SO AS TO MINIMIZE THE POTENTIAL FOR EROSION INTO EXISTING DRAINAGE INFRASTRUCTURE. STOCKPILES SHALL BE STABILIZED WITH HAYBALES, SILT FENCING OR EQUIVALENT. STOCKPILES LEFT FOR GREATER THAN 14 DAYS SHALL BE SEEDED WITH AN EROSION CONTROL MIX.
- REMOVAL OF ALL DEBRIS OR MATERIAL FROM THE WORK AREA SHALL BE DISPOSED OF IN ACCORDANCE WITH FEDERAL, STATE, AND LOCAL REGULATIONS UNDER THE OVERSIGHT OF A LICENSED SITE PROFESSIONAL (LSP).

WAIVERS:

- 1. SECTION 5.12.3.e: WAIVER REQUESTED TO USE HDPE, DOUBLE WALLED, SMOOTH INTERIOR PIPE IN PLACE OF REINFORCED CONCRETE DRAIN PIPE.
- 2. SECTION 5.3: WAIVER REQUESTED TO ALLOW 12" CURB INSTEAD OF 8" CURB.

ANTICIPATED PERMITS:

1. DEFINITIVE SUBDIVISION

- 2. TOPSFIELD STORMWATER AND EROSION CONTROL PERMIT
- 3. SCENIC ROAD PERMIT
- 4. EPA NPDES PERMIT

ZONING DISTRICTS:

- INNER RESIDENTIAL & AGRICULTURAL ZONING DISTRICT (IRA) OUTLYING RESIDENTIAL & AGRICULTURAL ZONING DISTRICT (ORA)
- GROUNDWATER PROTECTION DISTRICT
- IPSWICH RIVER PROTECTION DISTRICT

RIVERWOOD ESTATES DEFINITIVE SUBDIVISION

303 & 333 PERKINS ROW (ASSESSOR'S MAPS 27 & 20, LOT 43)

TOPSFIELD, MASSACHUSETTS

PREPARED FOR BURHANI, LLC

OCTOBER 16, 2017

ZONING DISTRICT: INNER RESIDENTIAL AND AGRICULTURE (IRA) / OUTLYING RESIDENTIAL AND AGRICULTURAL (ORA)





66 ELM STREET, DANVERS, MASSACHUSETTS 01923 P: 978-777-8586. F: 978-774-3488. W: WWW.MORINCAMERON.COM I HEREBY CERTIFY THAT THIS PLAN HAS BEEN

LAND SURVEYORS | LAND USE PLANNERS

COMMONWEALTH OF MASSACHUSETTS. 10.16.17

PREPARED IN CONFORMANCE WITH THE RULES AND

REGULATIONS OF THE REGISTERS OF DEEDS OF THE

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TOWN CLERK

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BOOK No	_, PAGE No
APPROVAL UNDER THE CONTROL LAW REQUIRED	
DATE OF APPLICATION:	OCTOBER 17, 2017
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DATE OF APPROVAL:	
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GENERAL NOTES LEGEND & **ABBREVIATIONS** DRAWING NO.

2 of 20

PROJ. #3460 DRAWING: 3460 LAYOUT

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NORTH AMERICAN VERTICAL

NAVD



АТ

303 & 333 PERKINS ROW

(ASSESSOR'S MAPS 27 & 20, LOT 43)
TOPSFIELD, MASSACHUSETTS

PREPARED FOR BURHANI, LLC

OCTOBER 16, 2017

SCALE: 1" = 200'

0 100 200 400 8
ZONING DISTRICT: INNER RESIDENTIAL AND

AGRICULTURE (IRA) / OUTLYING RESIDENTIAL AND AGRICULTURAL (ORA)

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MASSACHUSE VIS REGISTERED DA

I, _____ CLERK OF THE TOWN OF TOPSFIELD, HEREBY CERTIFY THAT THE NOTICE OF APPROVAL OF THIS PLAN BY THE PLANNING BOARD WAS RECEIVED ON _____ AND RECORDED AT THIS OFFICE AND NO NOTICE OF APPEAL WAS RECEIVED DURING THE TWENTY DAYS NET FOLLOWING SUCH RECEIPT AND RECORDING OF SAID NOTICE.

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OCTOBER 17, 2017




TOPSFIELD PLANNING BOARD


INDEX PLAN & KEY MAP


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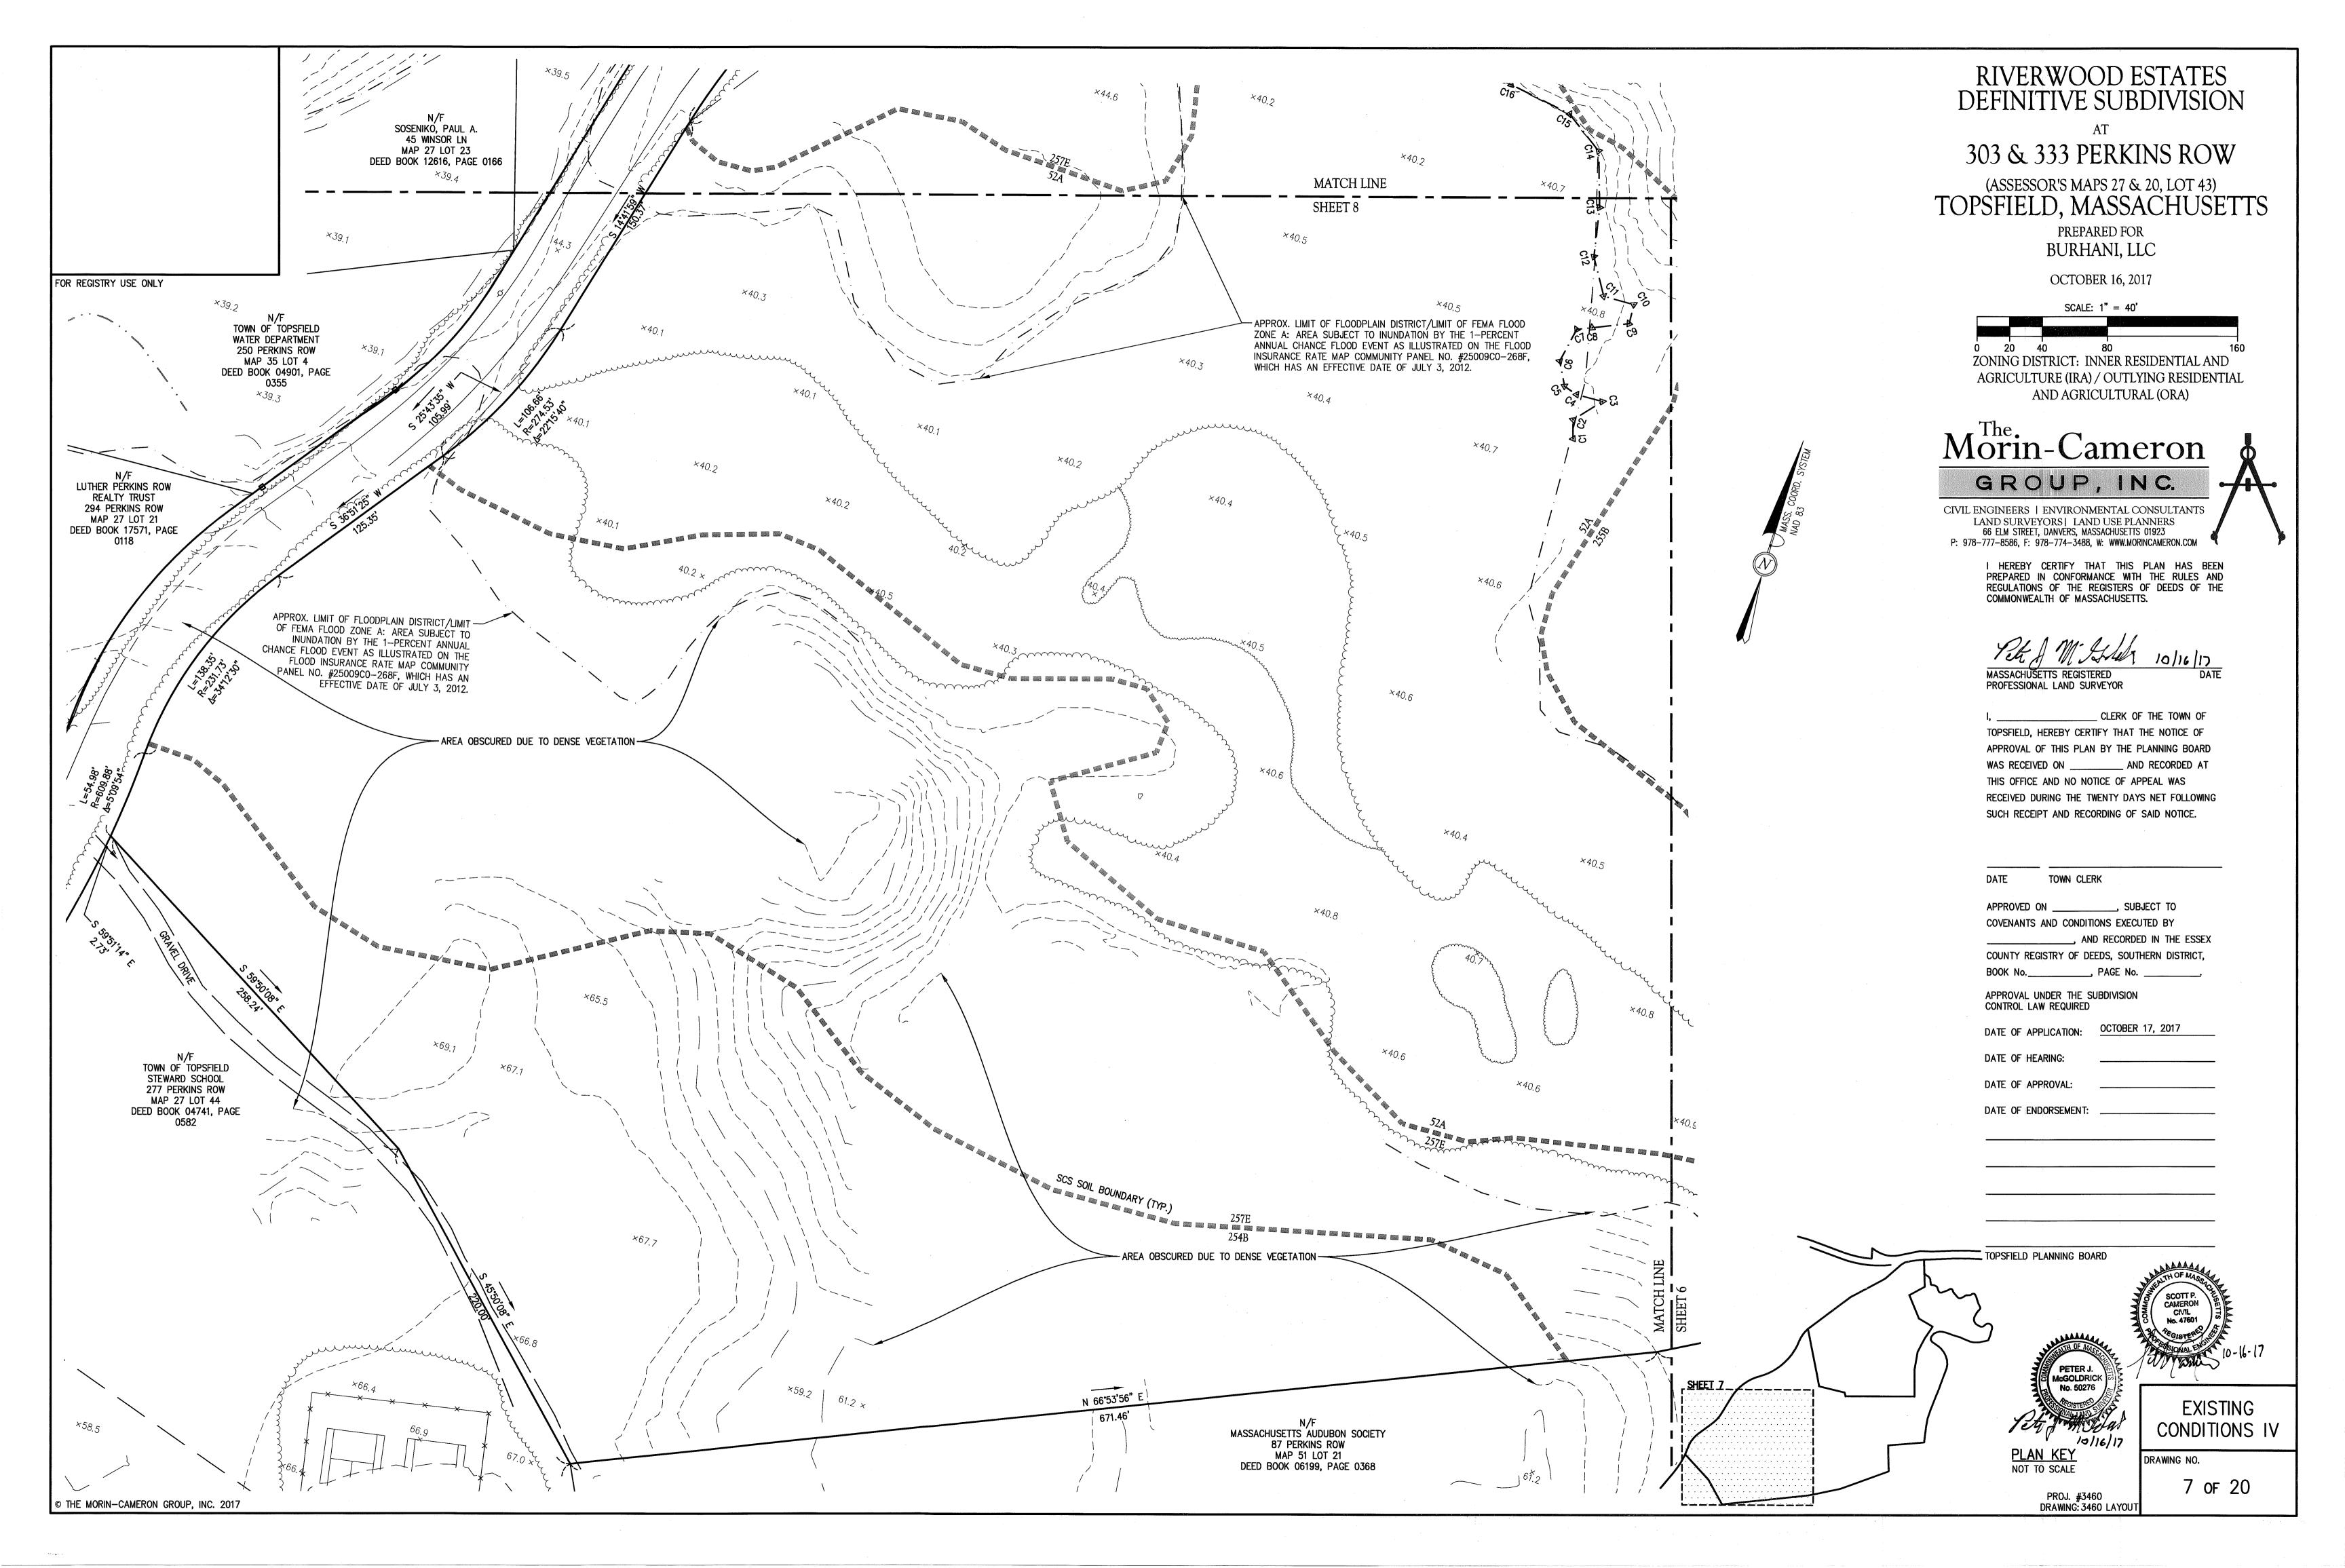
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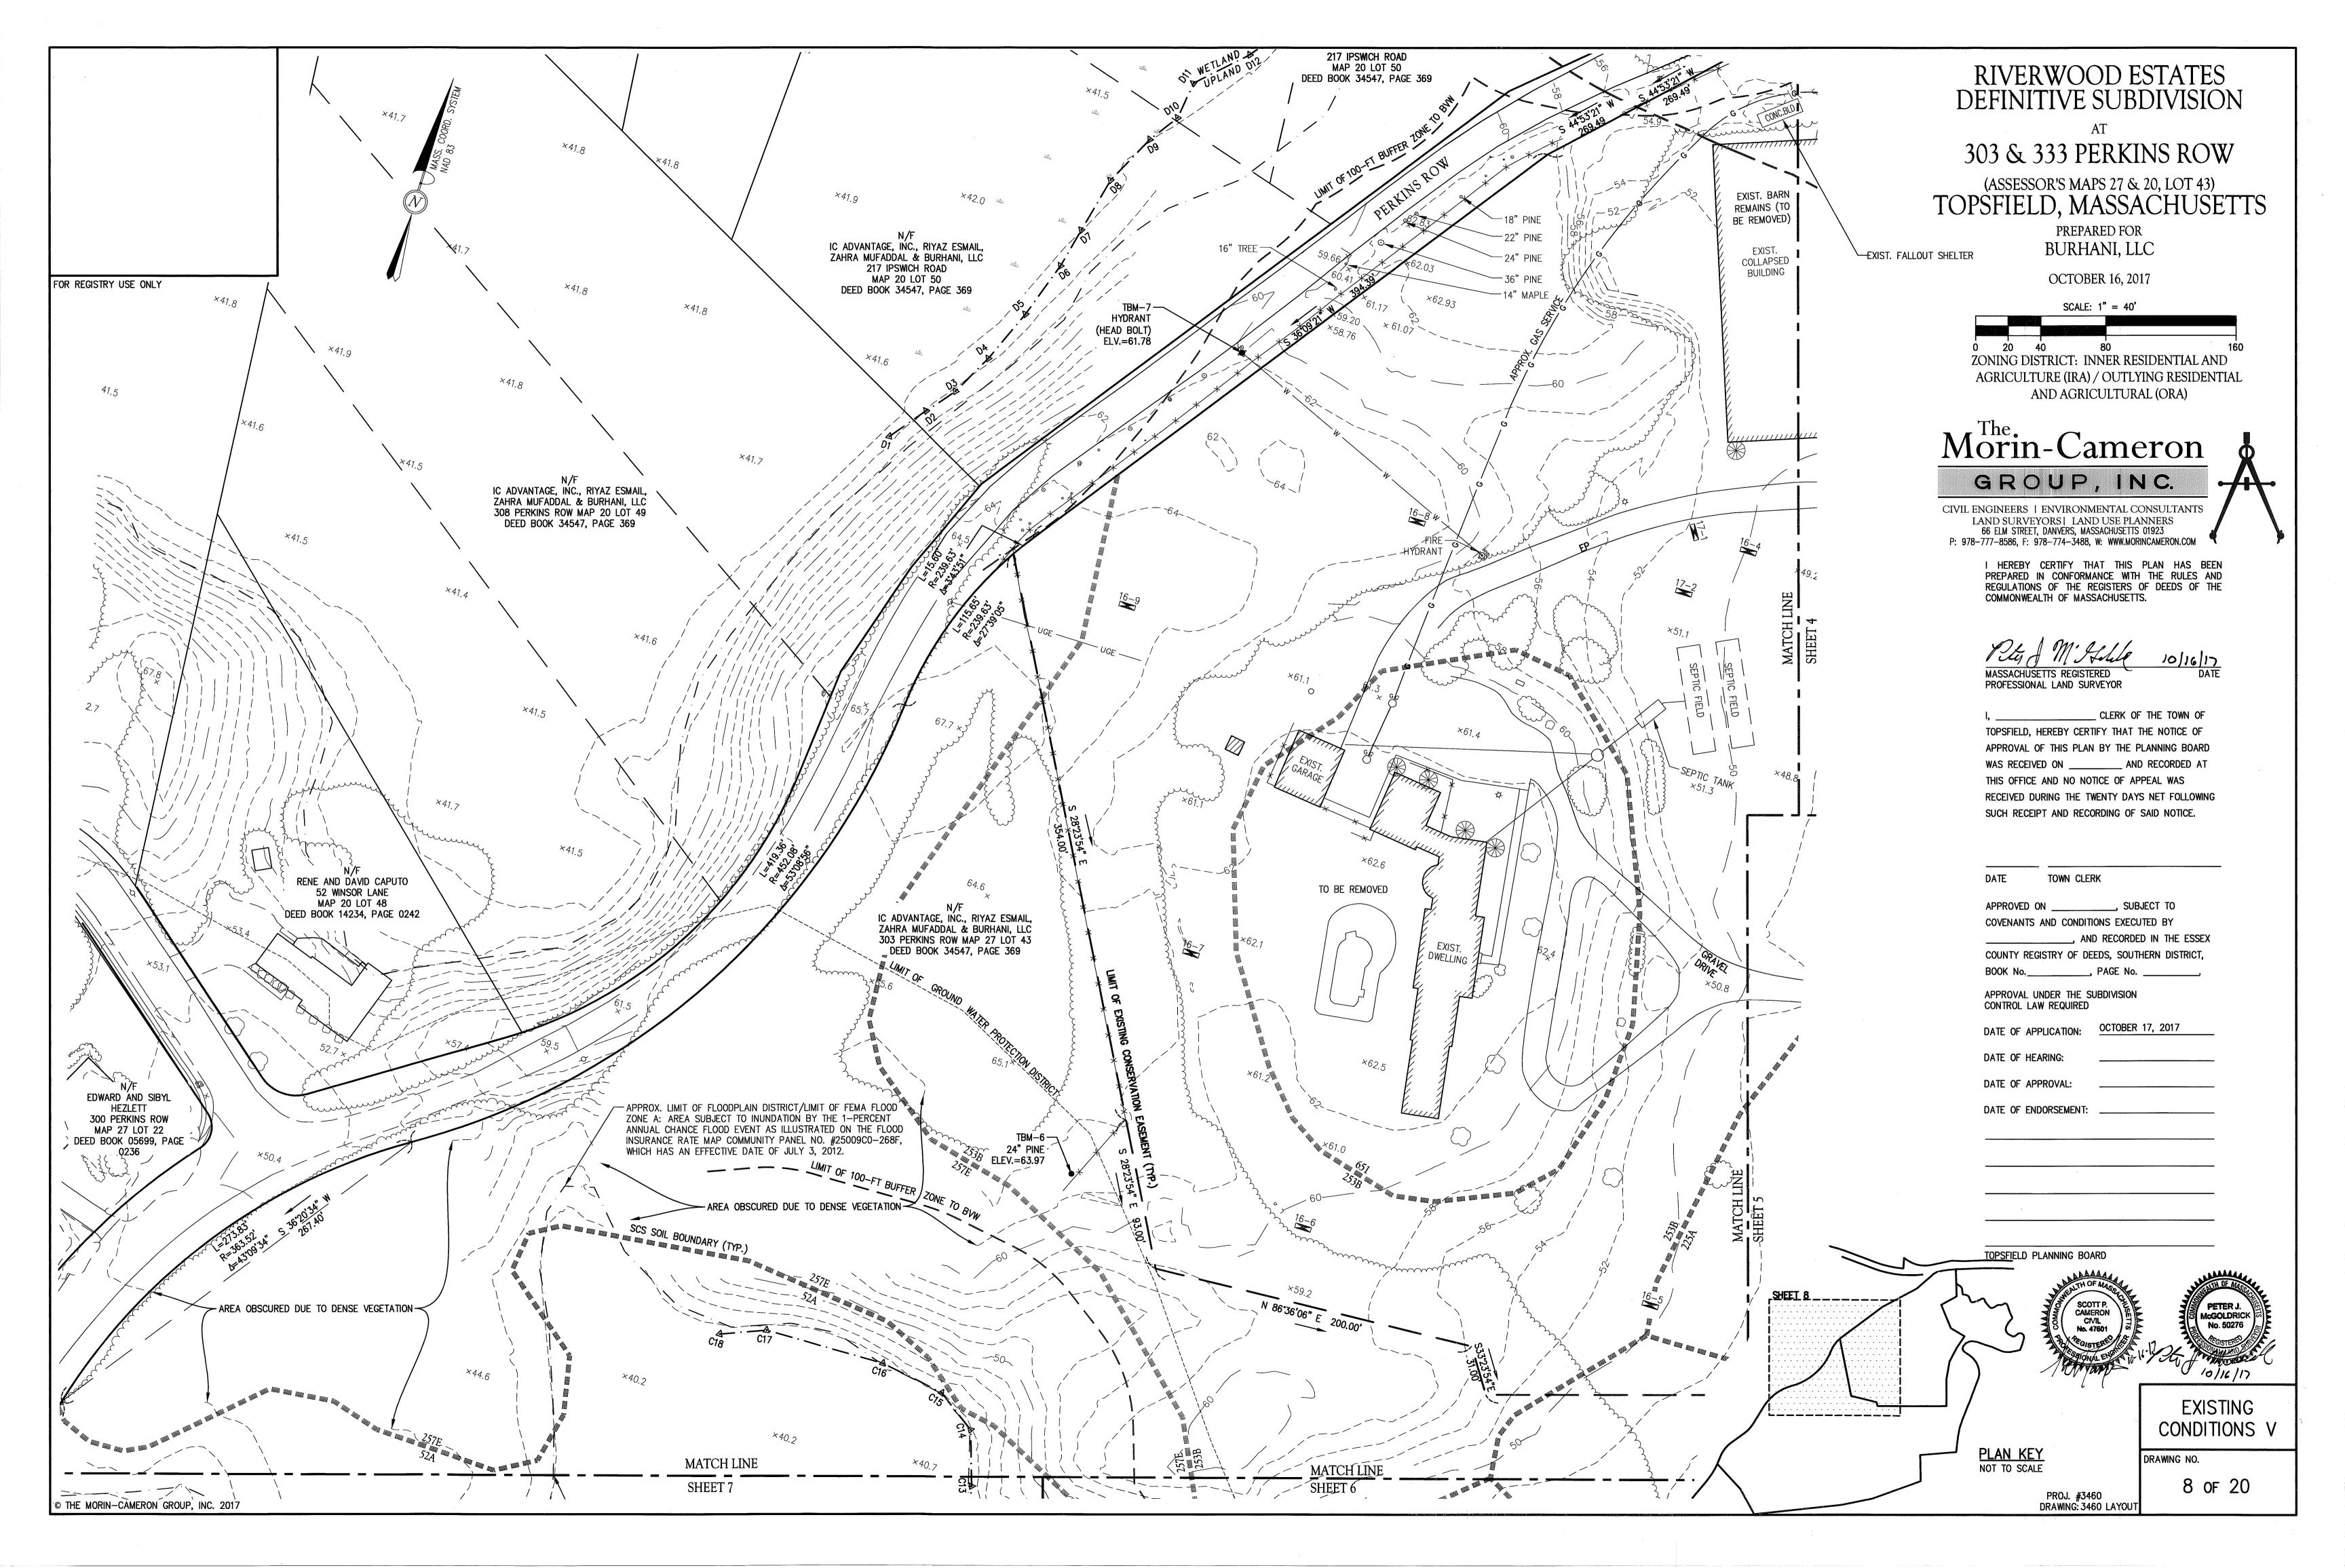
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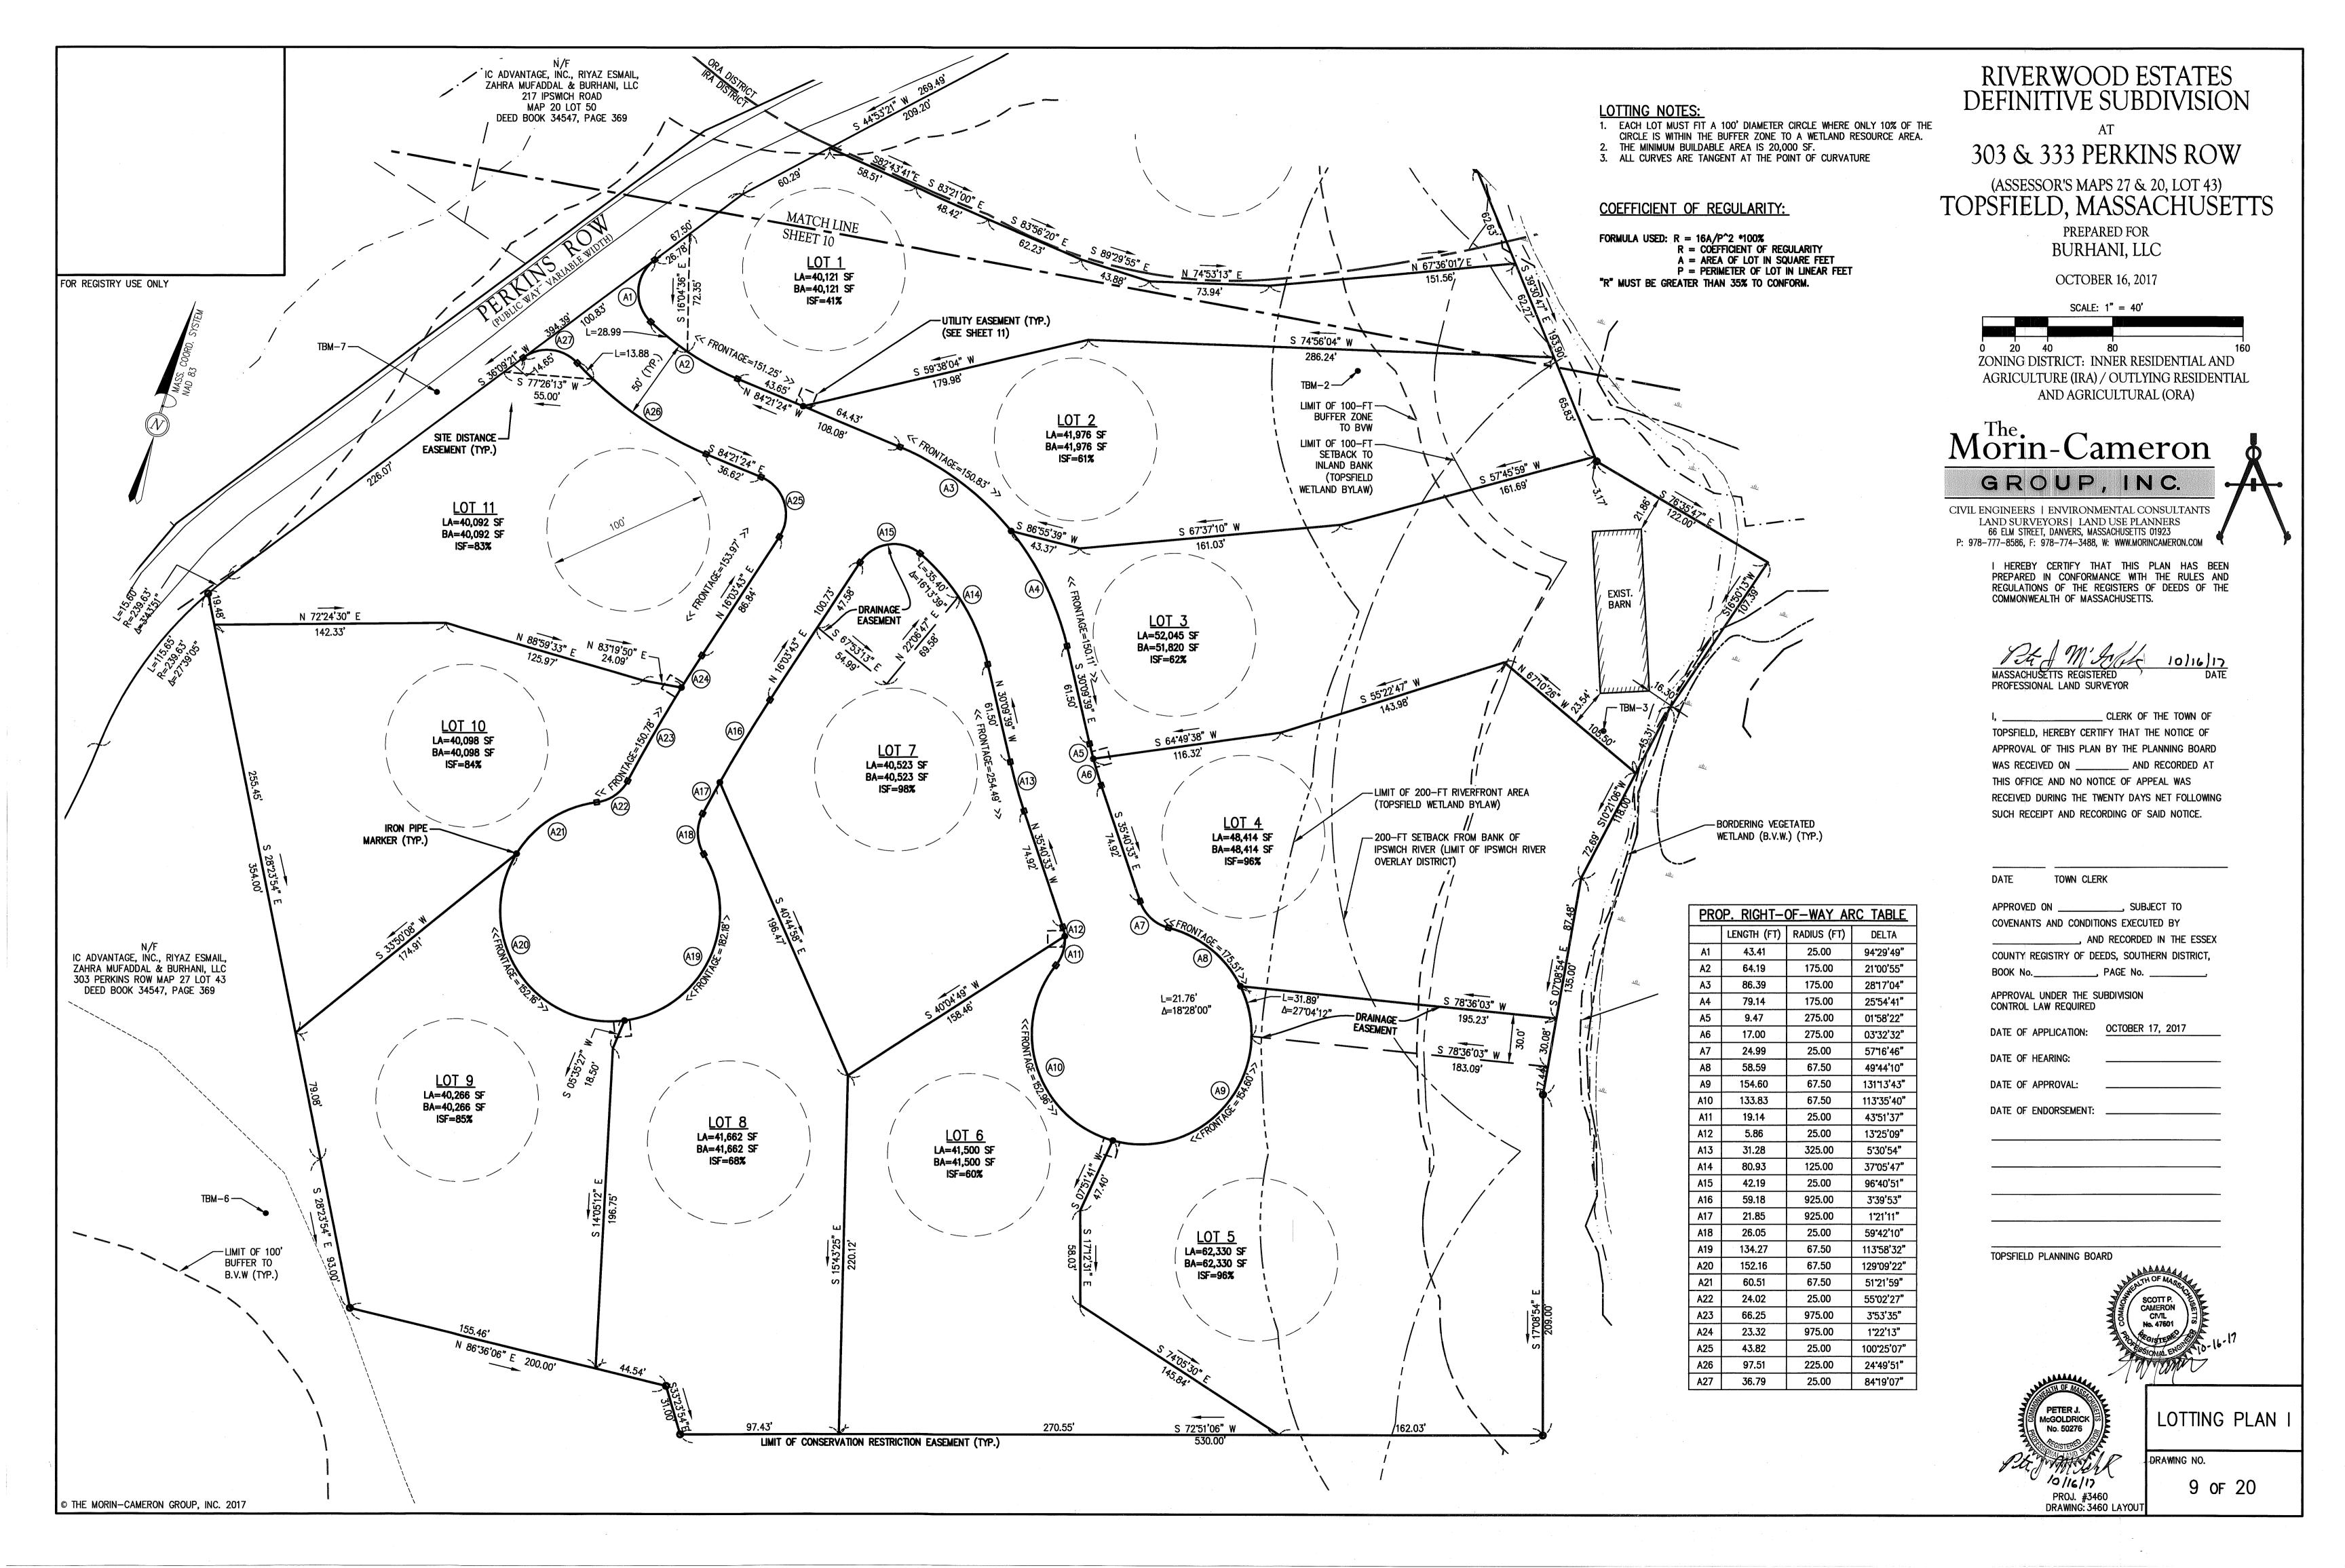







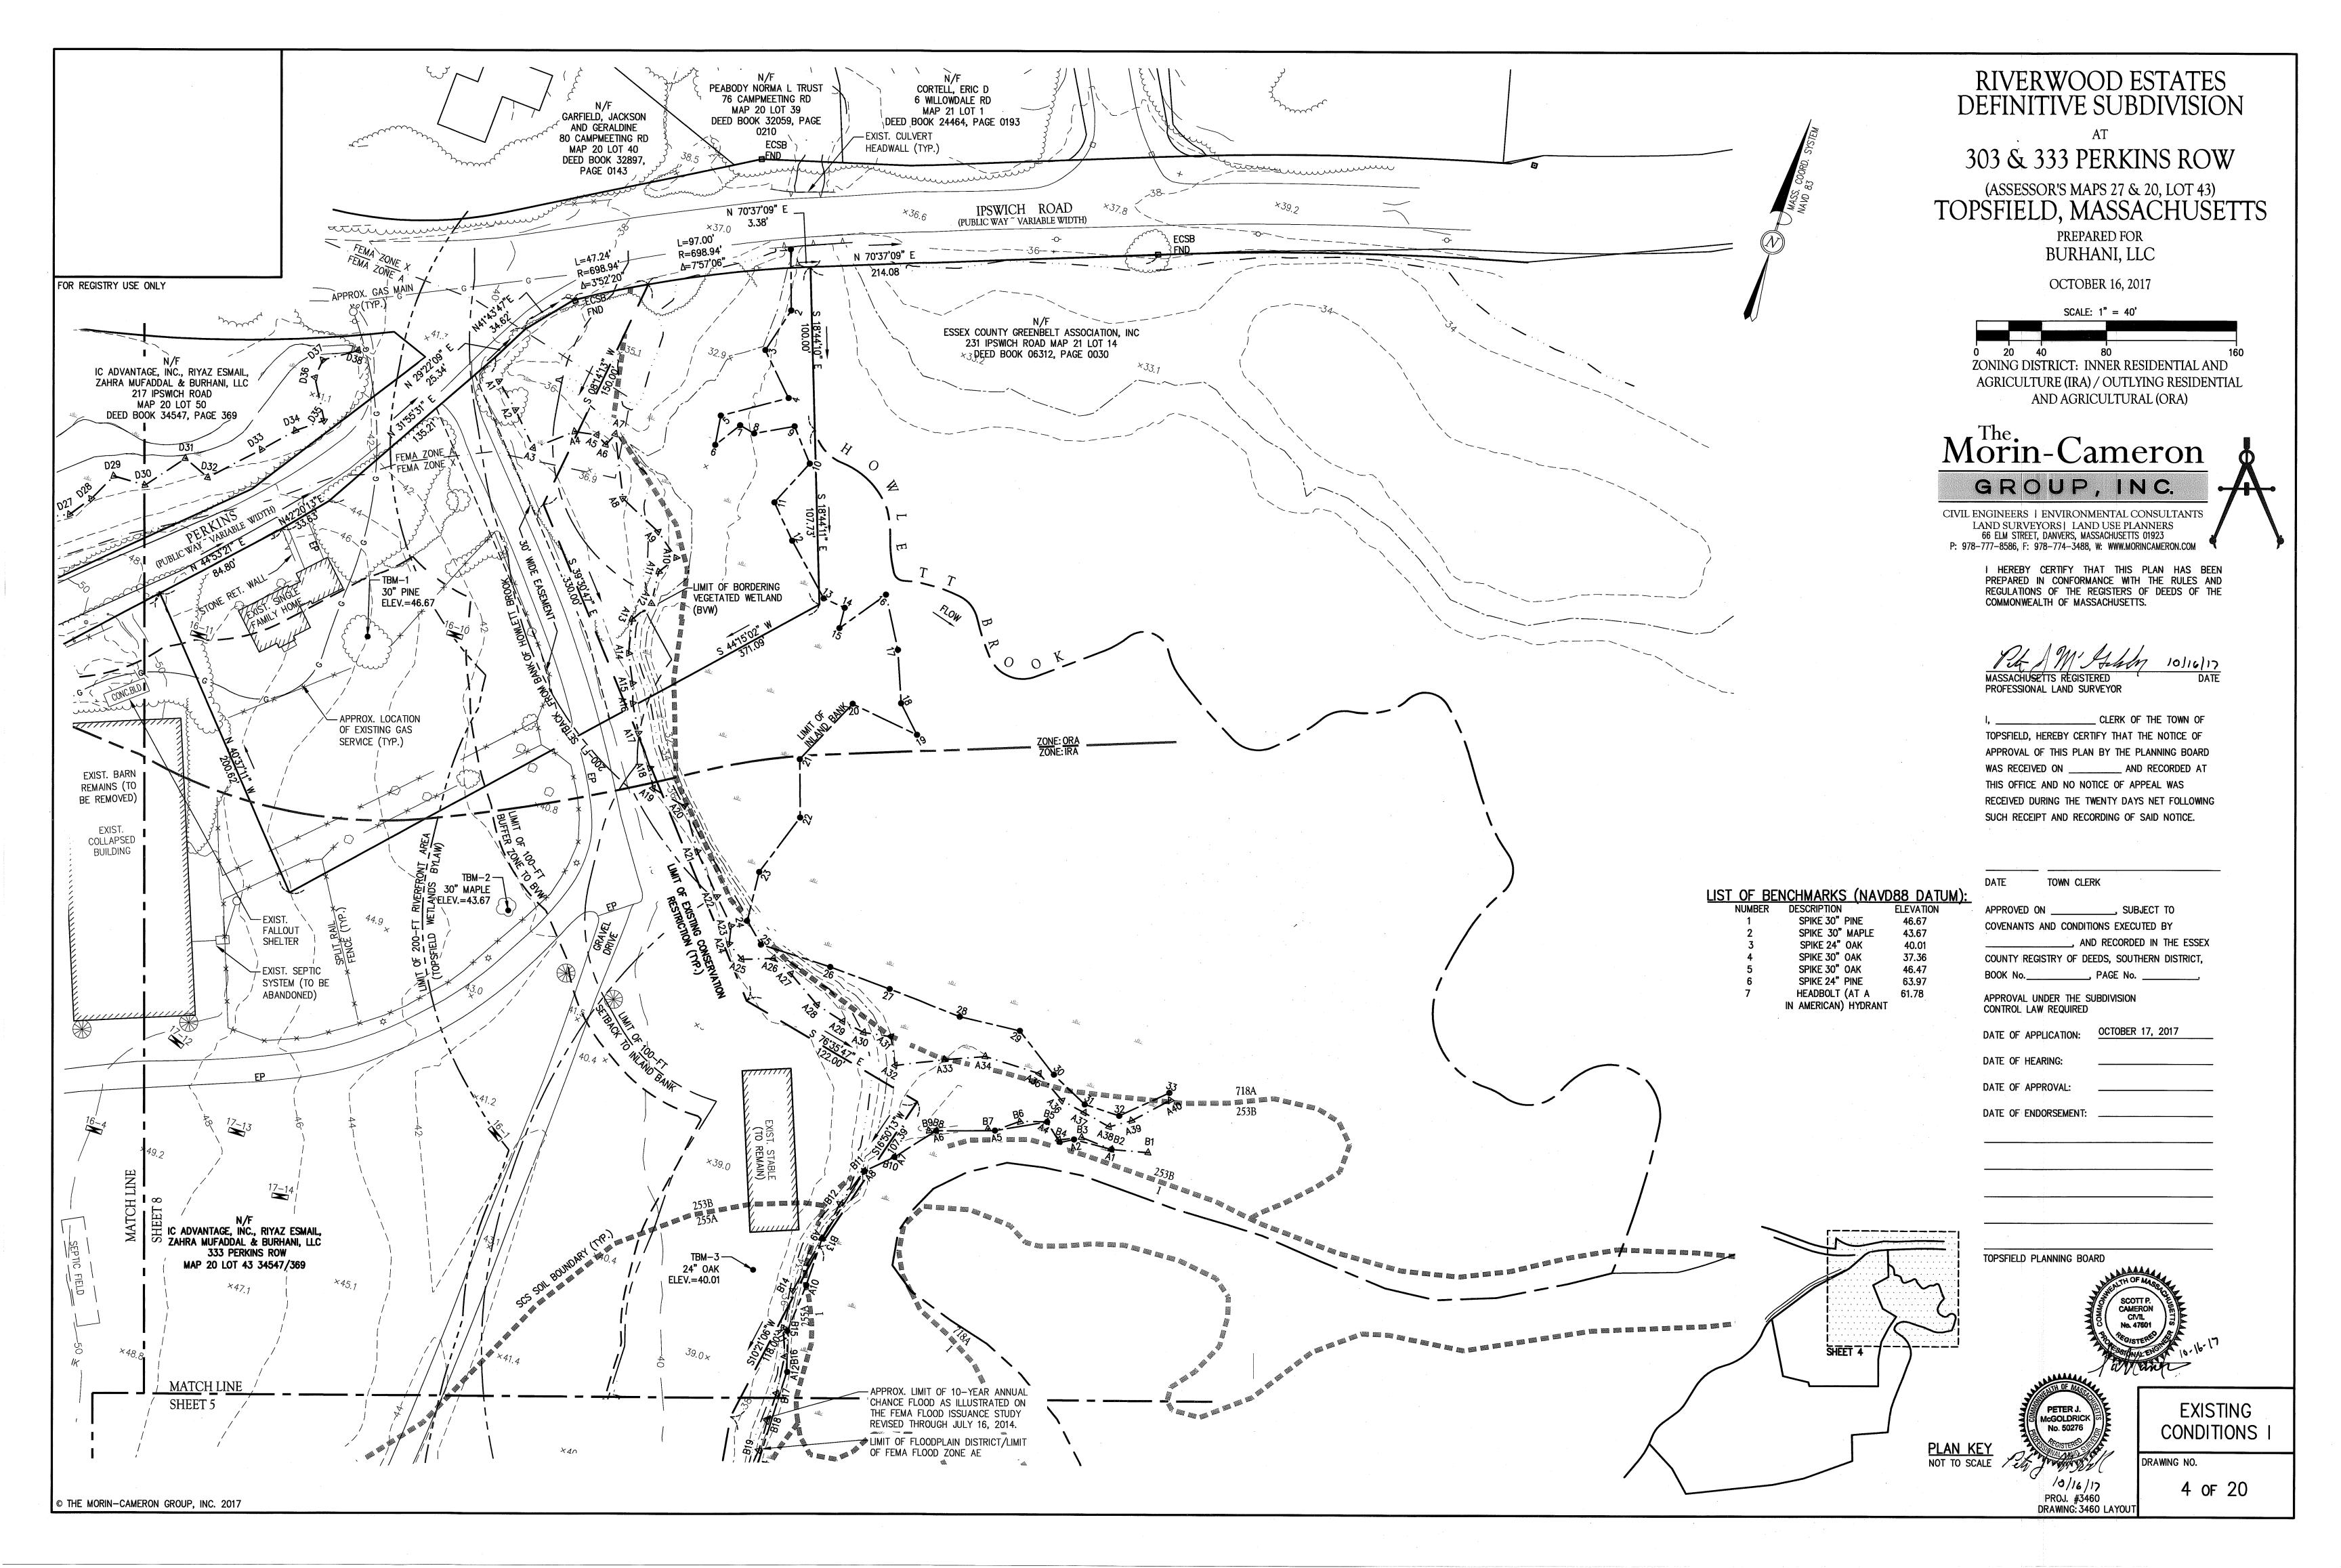

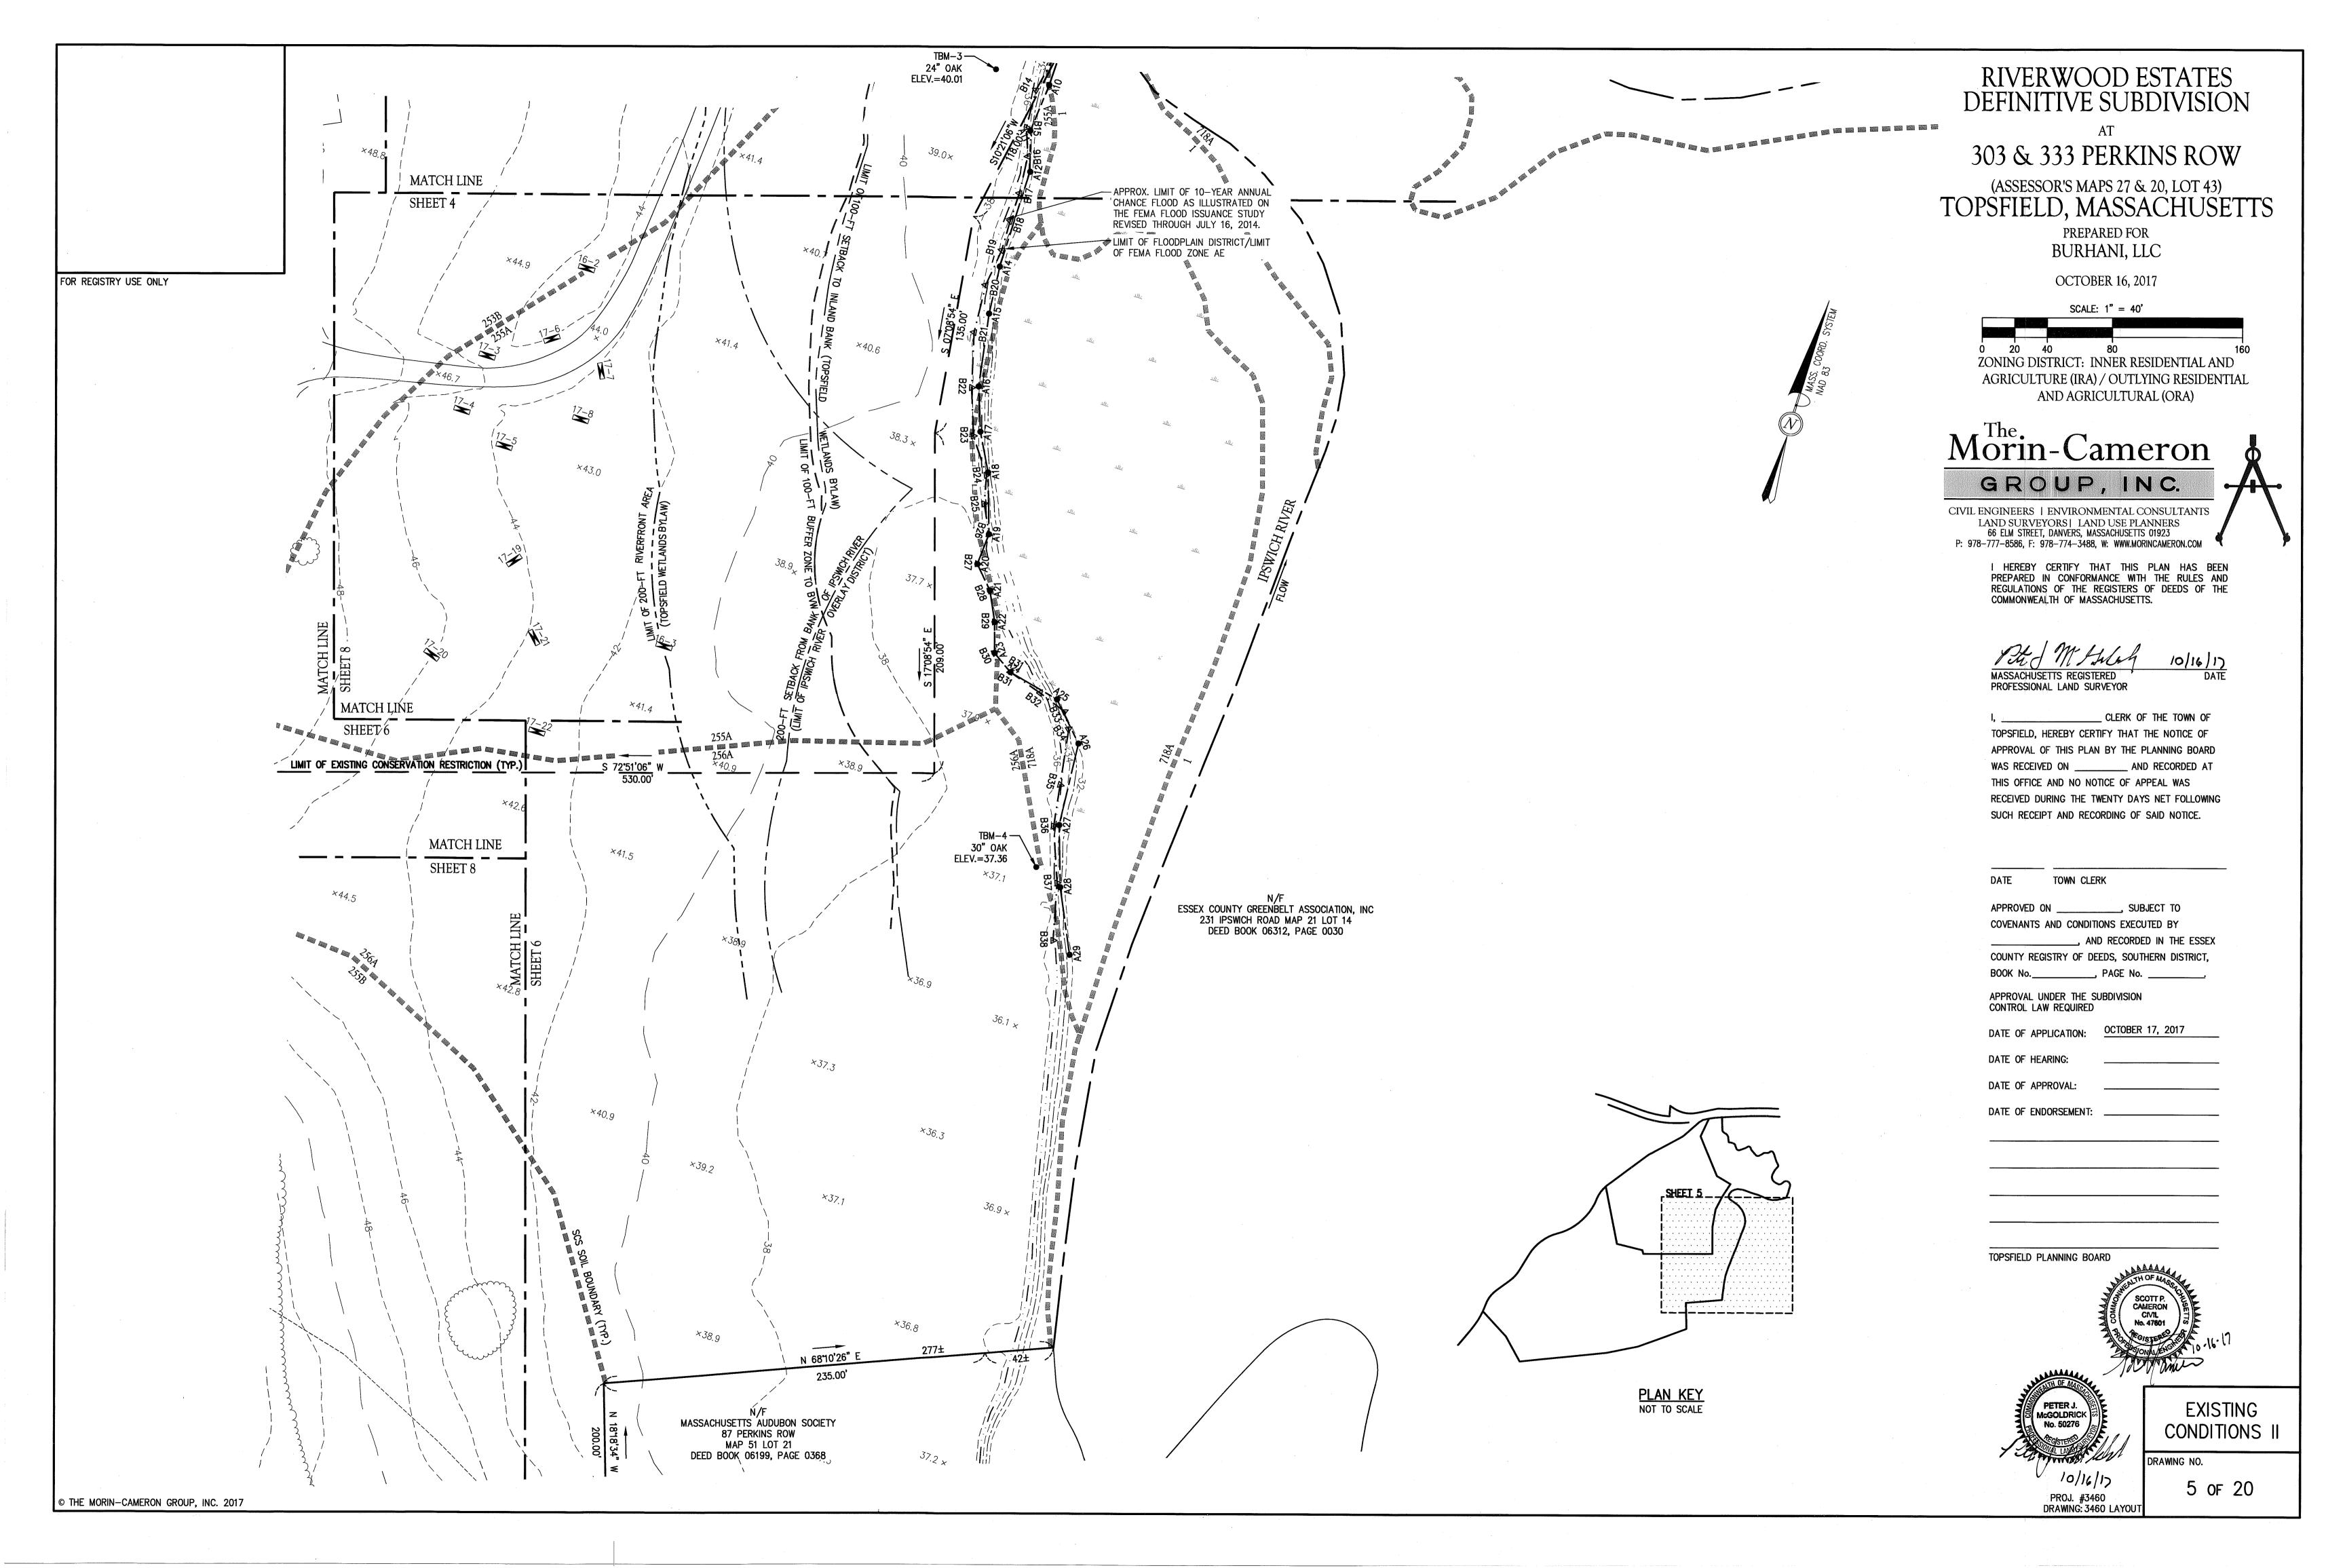


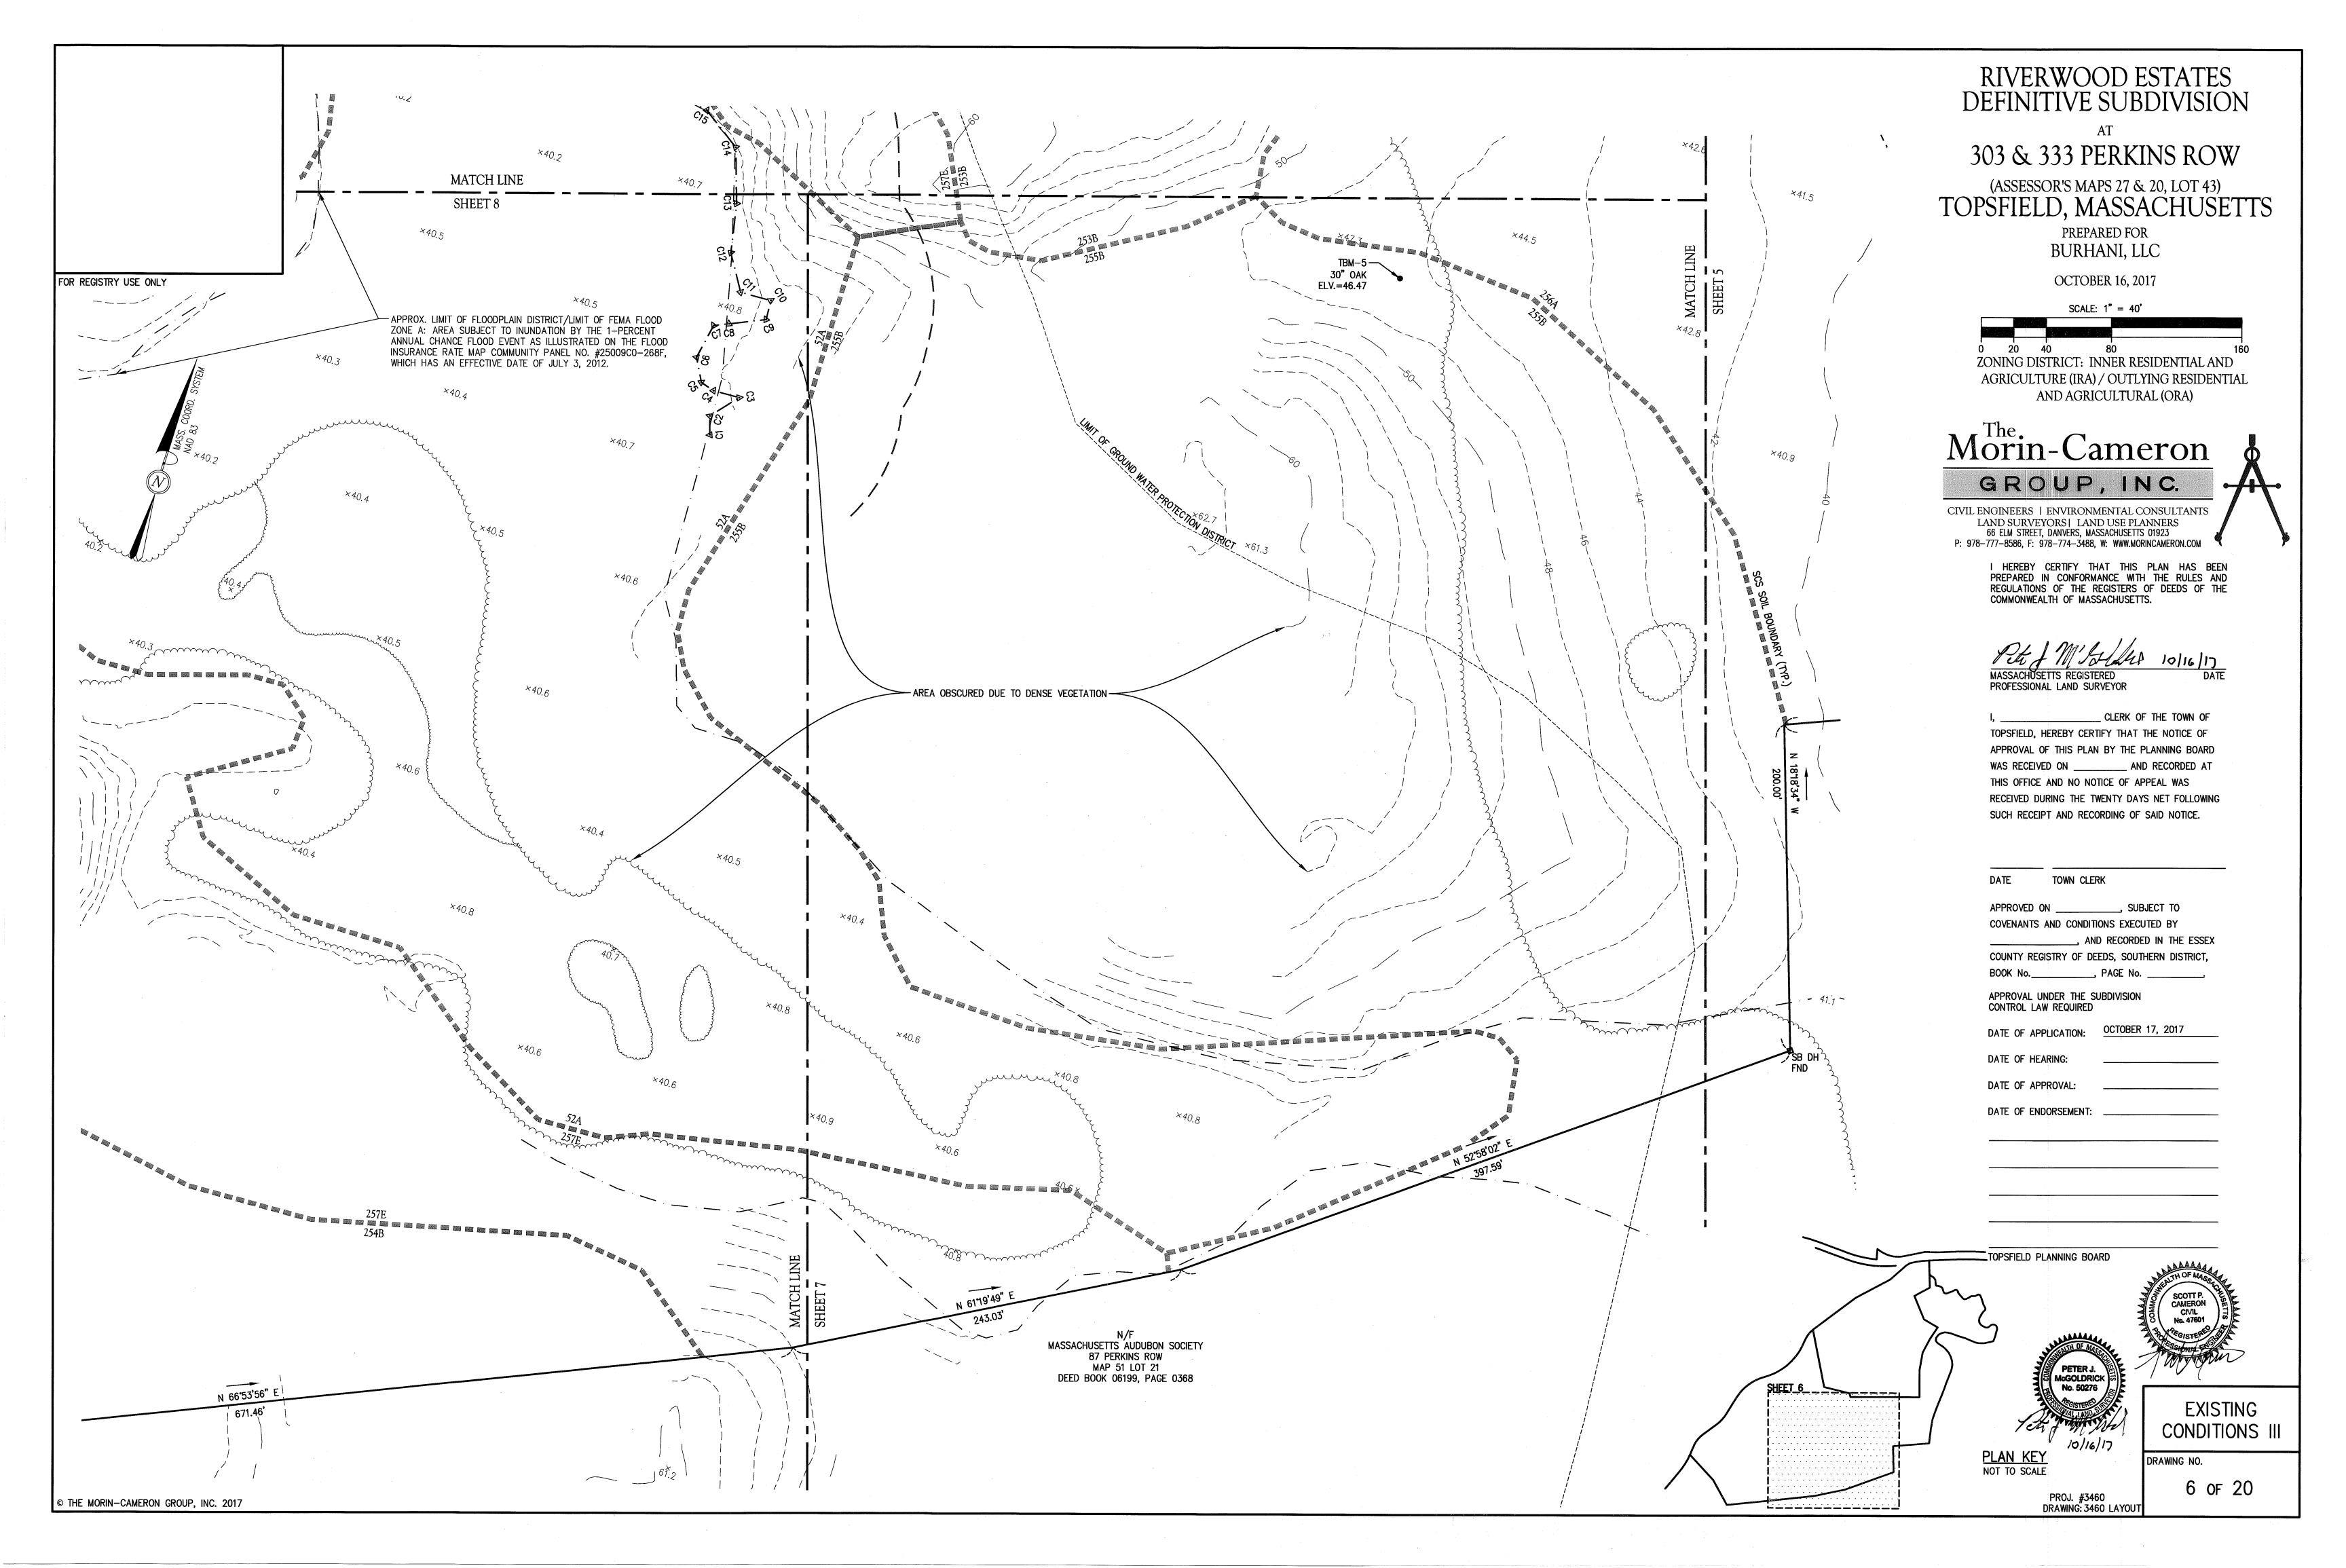


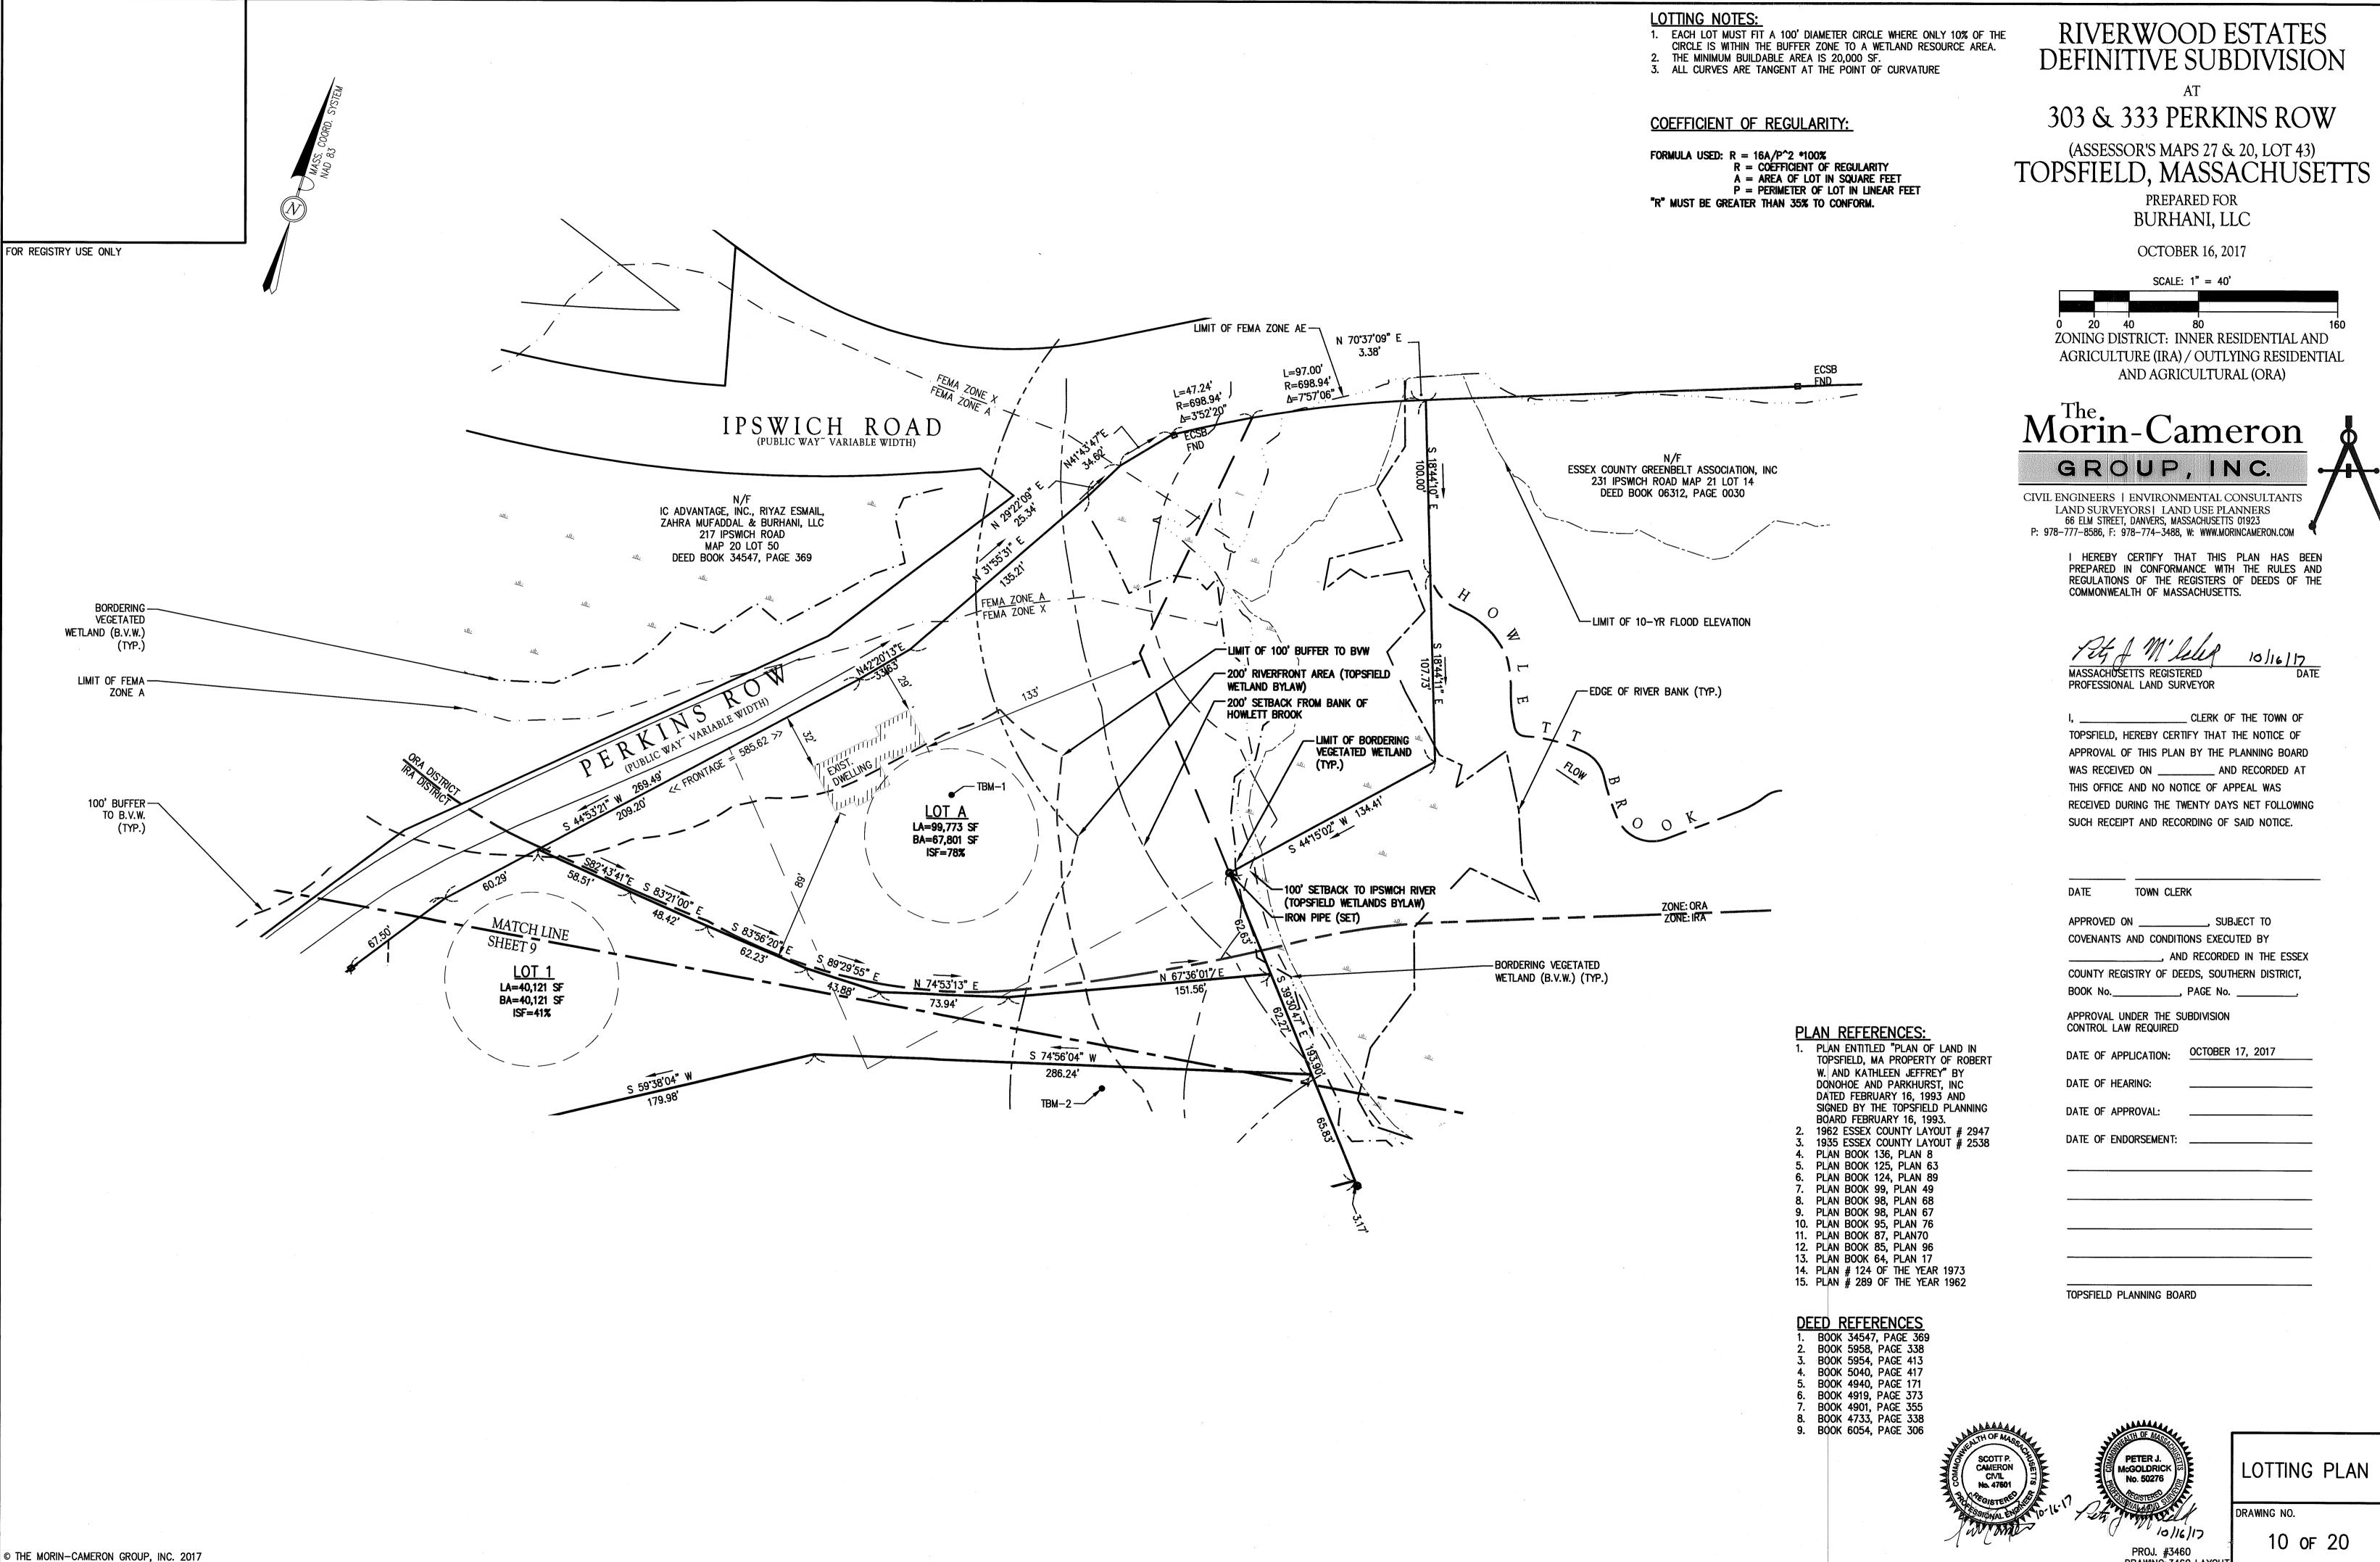

LOTTING PLAN II

DRAWING: 3460 LAYOUT

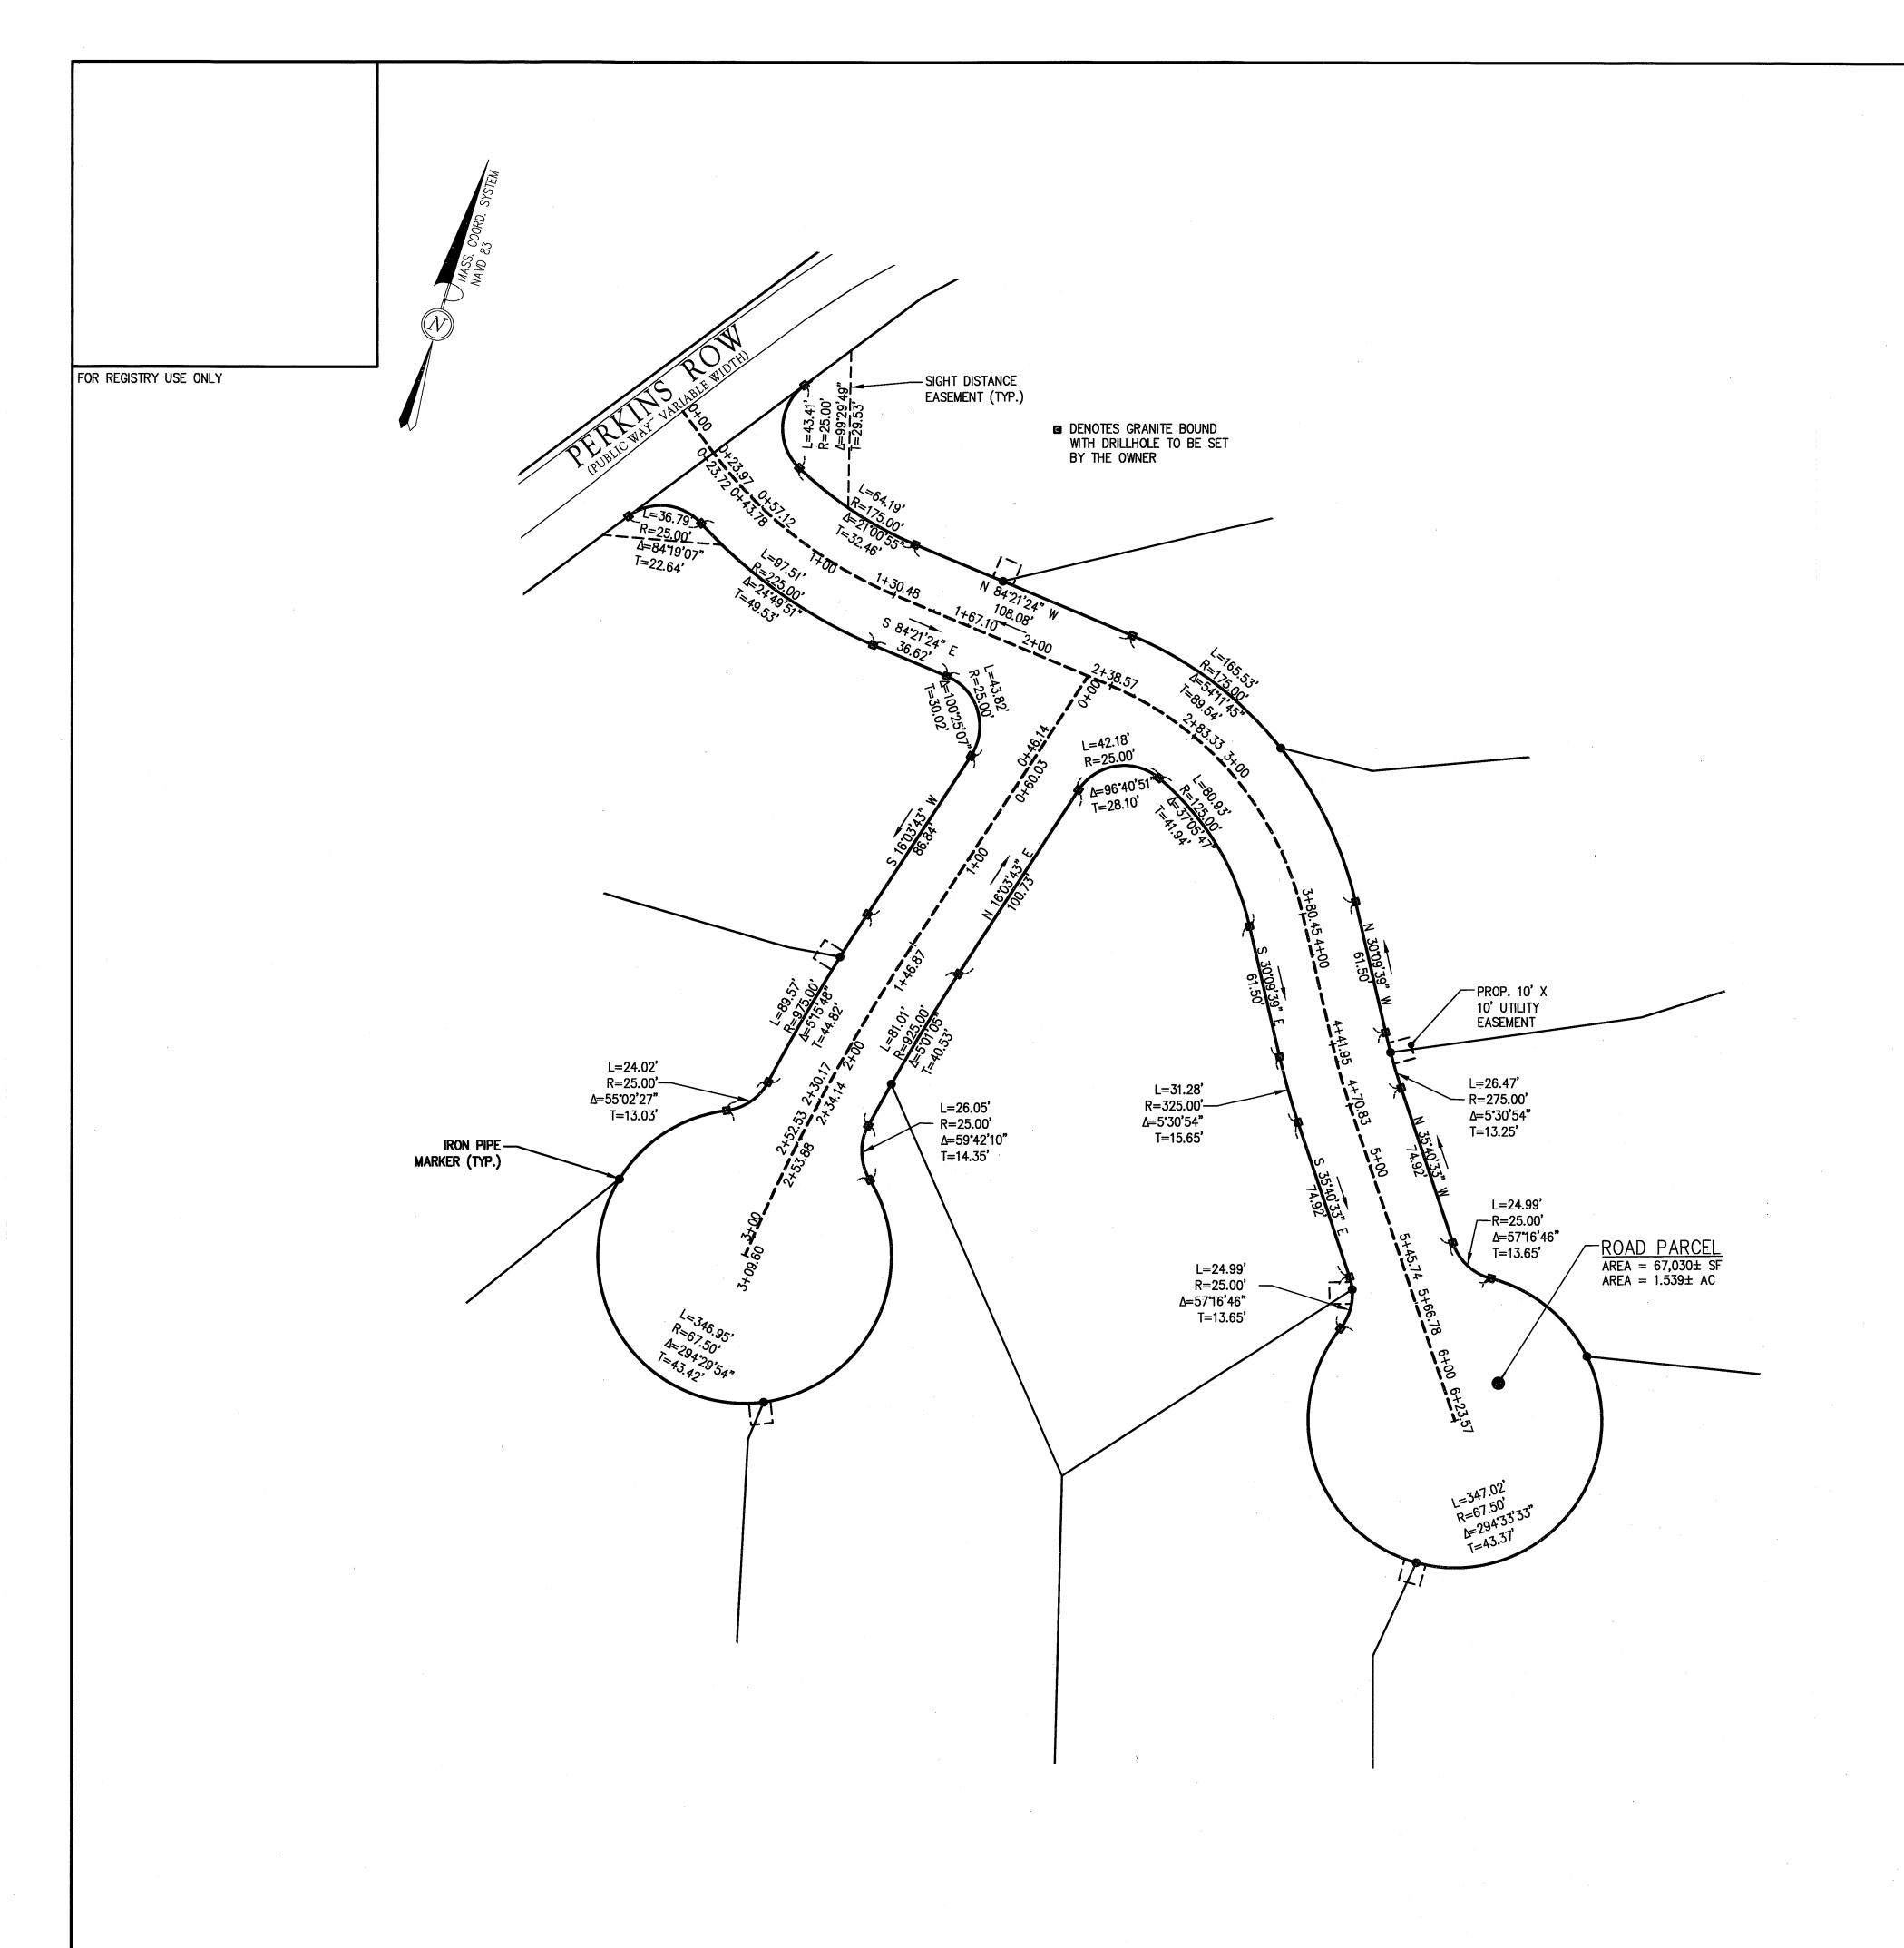

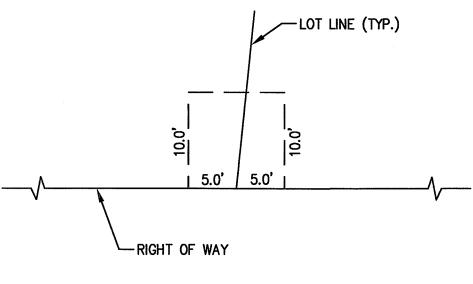

TYPICAL 10' X 10' WIDE UTILITY EASEMENT: (NOT TO SCALE)

AT

303 & 333 PERKINS ROW

(ASSESSOR'S MAPS 27 & 20, LOT 43) TOPSFIELD, MASSACHUSETTS

PREPARED FOR BURHANI, LLC

OCTOBER 16, 2017

ZONING DISTRICT: INNER RESIDENTIAL AND AGRICULTURE (IRA) / OUTLYING RESIDENTIAL AND AGRICULTURAL (ORA)

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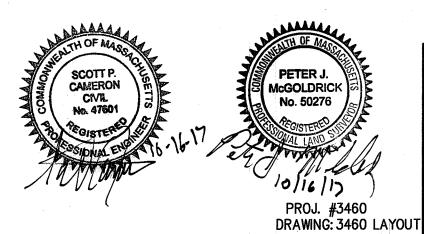
I HEREBY CERTIFY THAT THIS PLAN HAS BEEN PREPARED IN CONFORMANCE WITH THE RULES AND REGULATIONS OF THE REGISTERS OF DEEDS OF THE COMMONWEALTH OF MASSACHUSETTS.

MASSACHUSETTS REGISTERED DA PROFESSIONAL ENGINEER

I, ______ CLERK OF THE TOWN OF TOPSFIELD, HEREBY CERTIFY THAT THE NOTICE OF APPROVAL OF THIS PLAN BY THE PLANNING BOARD WAS RECEIVED ON ______ AND RECORDED AT THIS OFFICE AND NO NOTICE OF APPEAL WAS RECEIVED DURING THE TWENTY DAYS NET FOLLOWING SUCH RECEIPT AND RECORDING OF SAID NOTICE.

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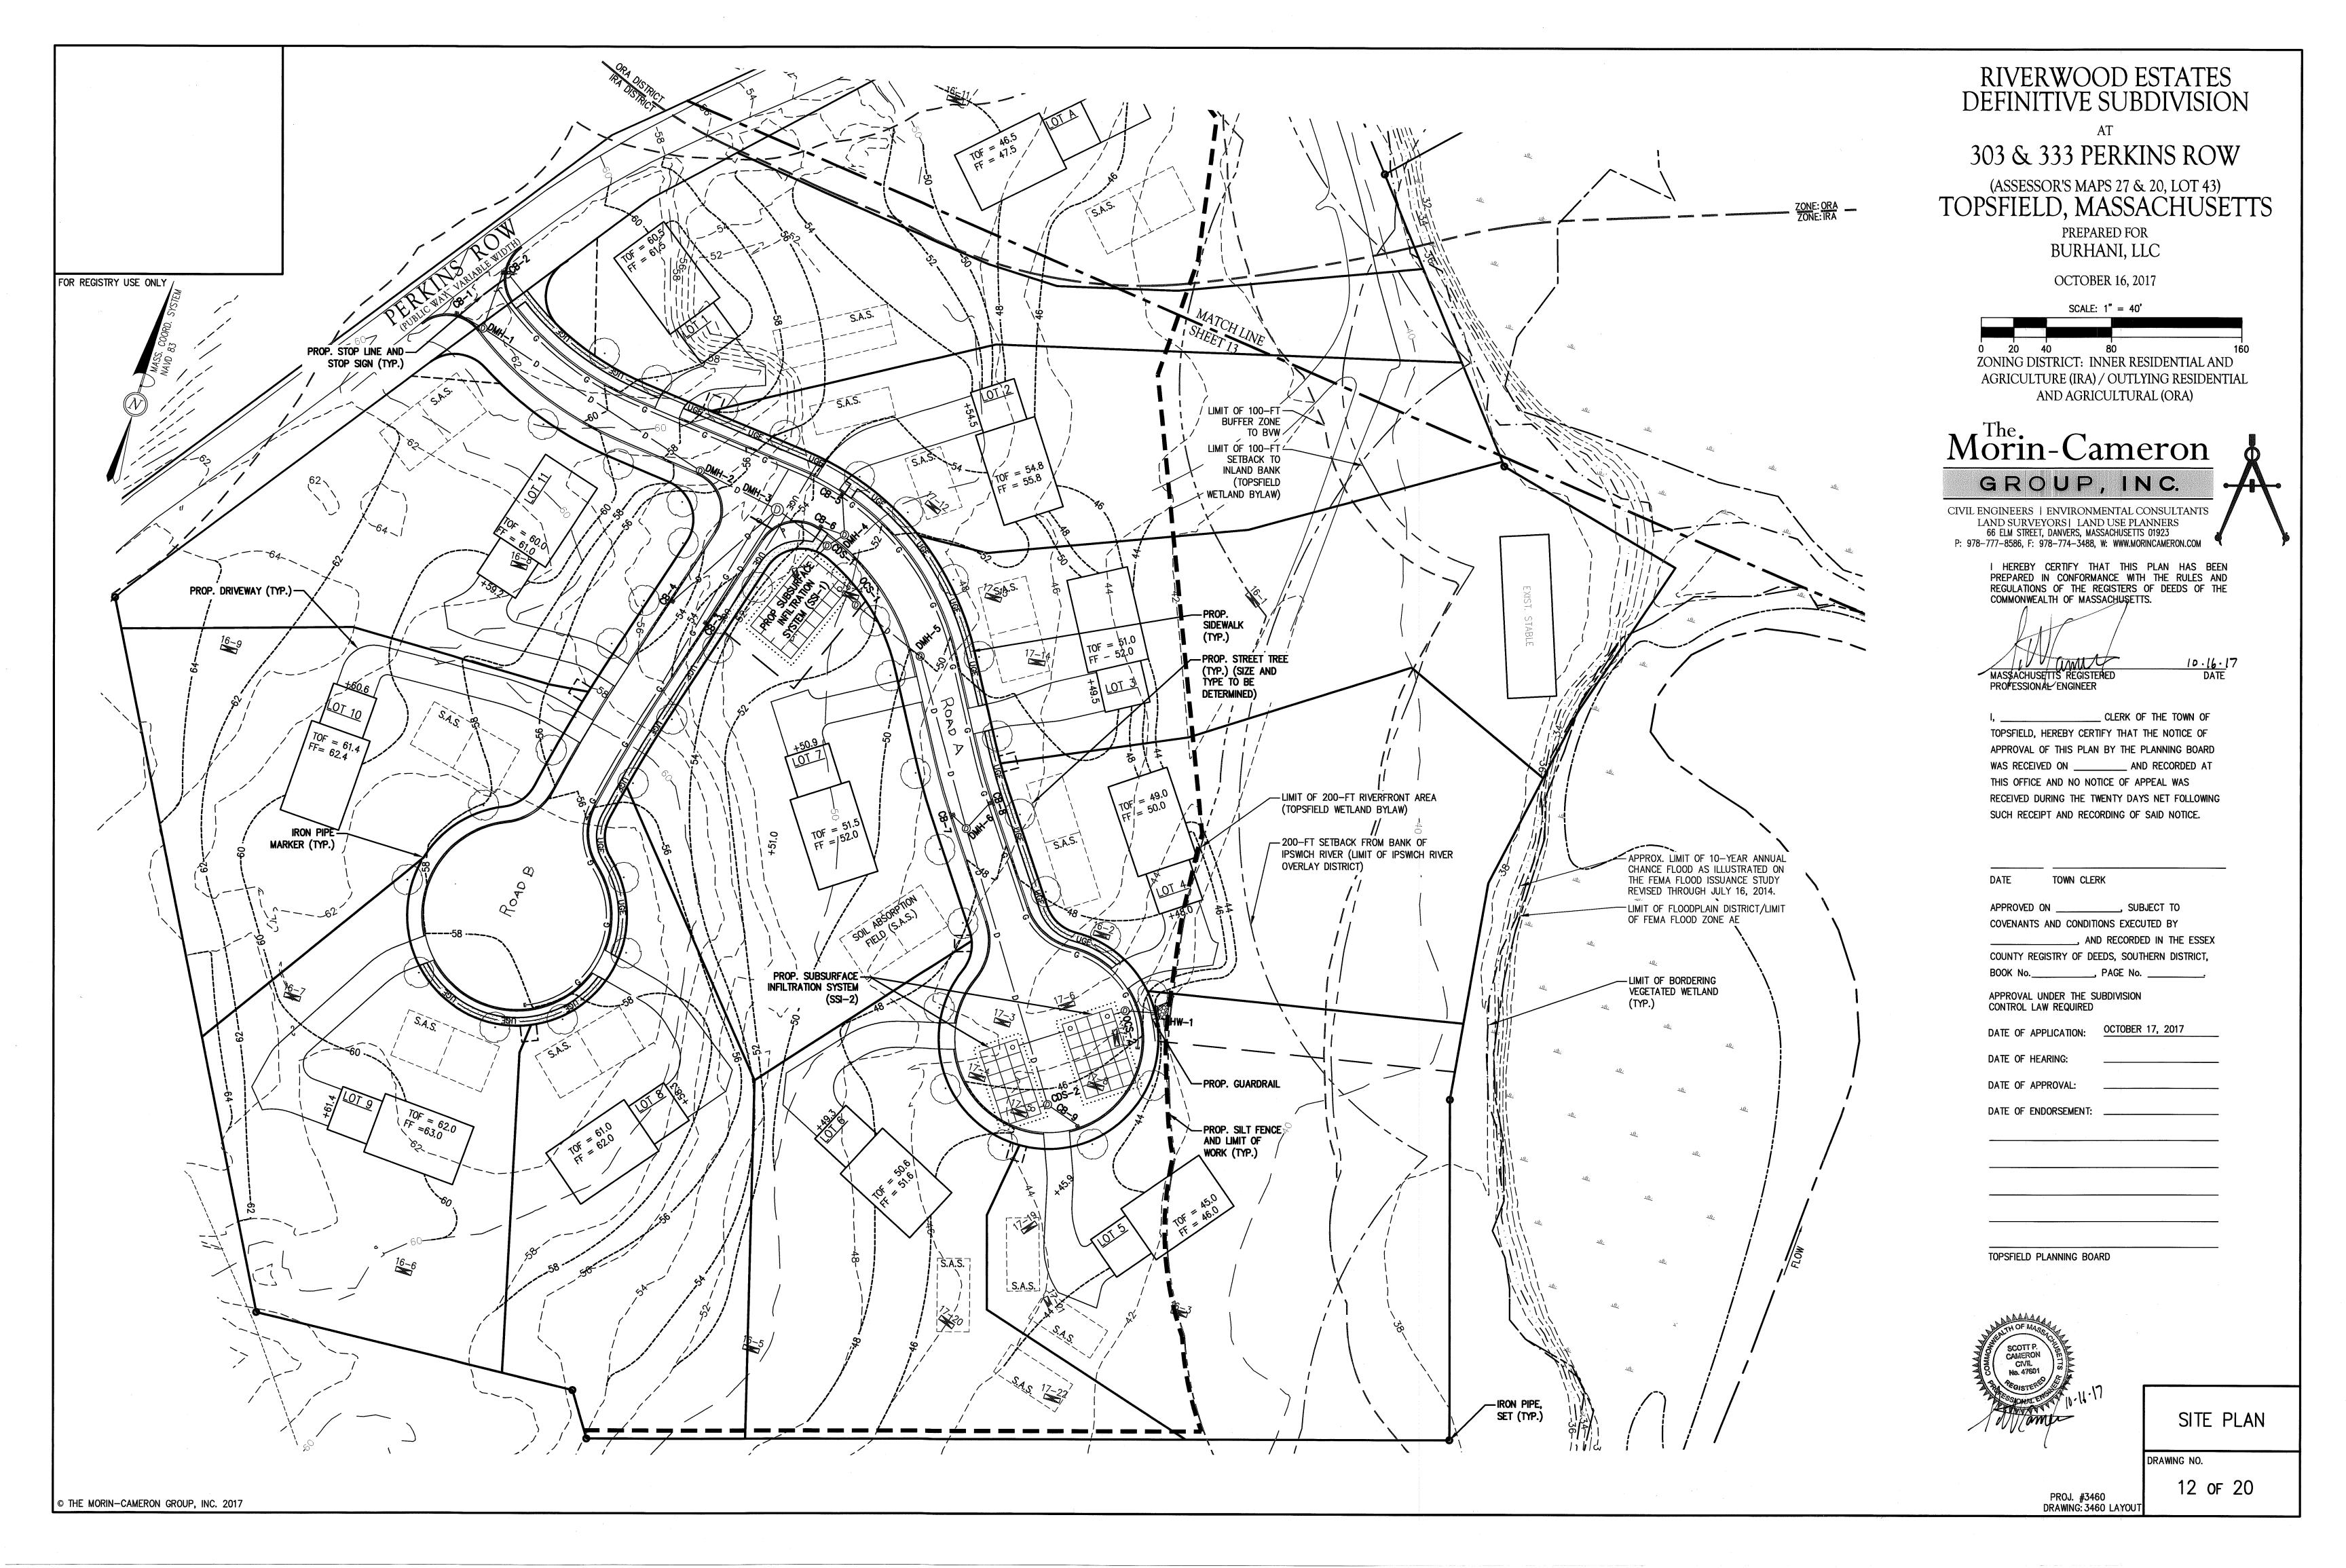
TOPSFIELD PLANNING BOARD




ROAD GEOMETRY

DRAWING NO.

11 of 20



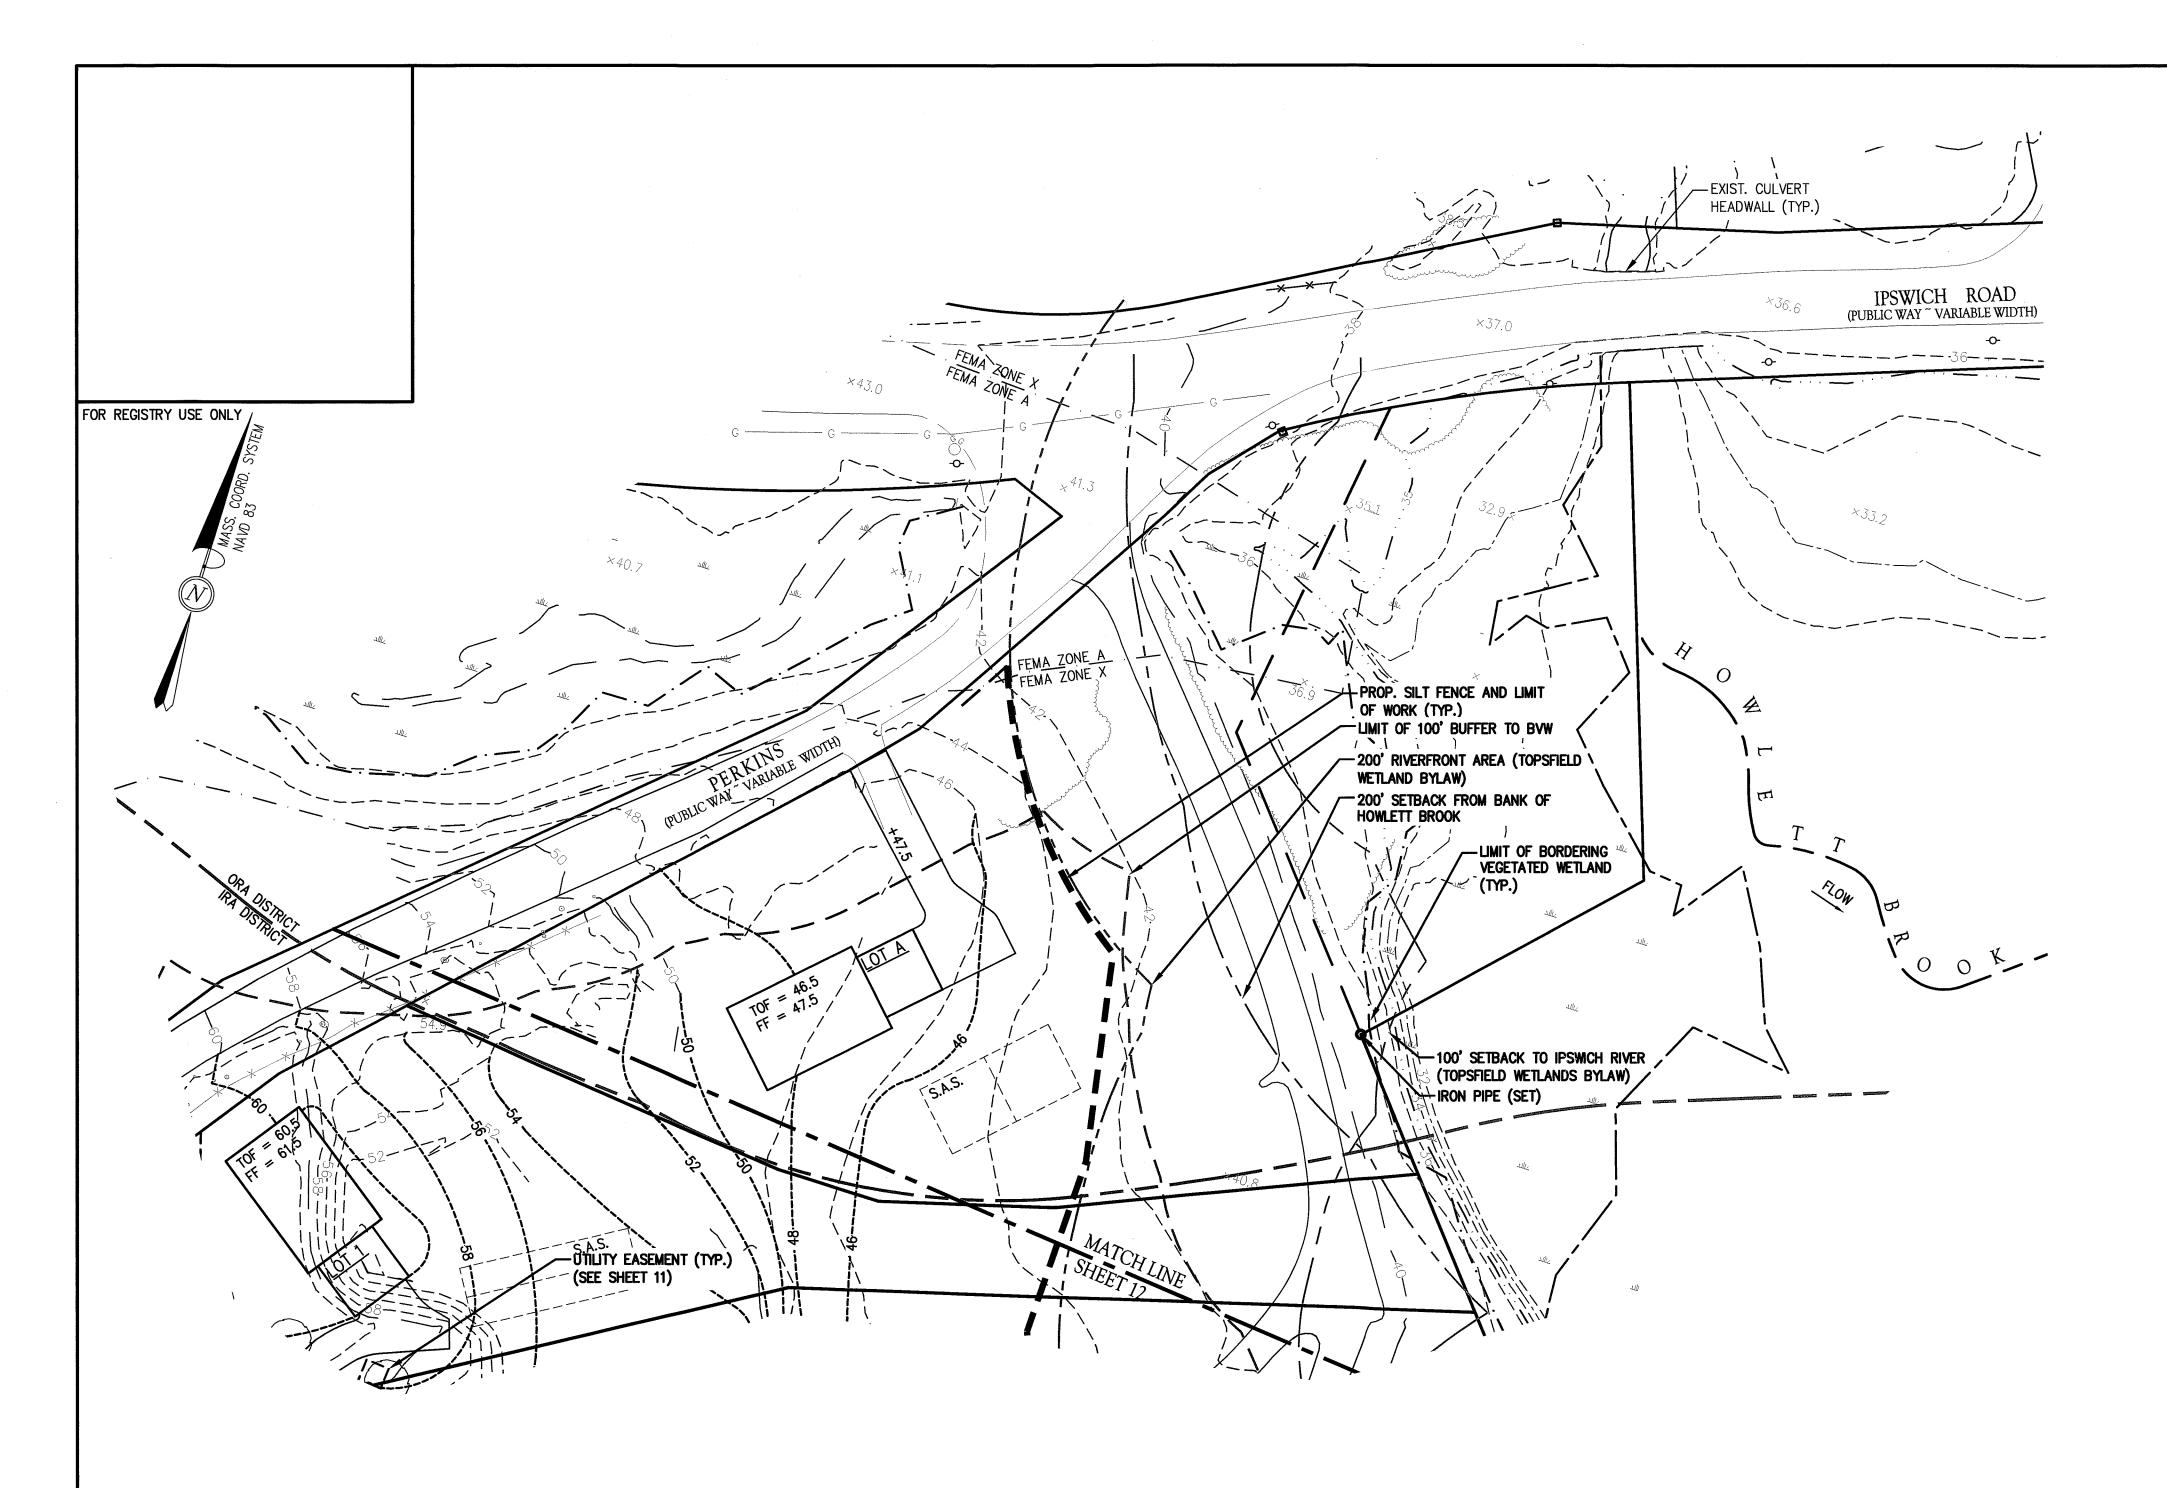

PIPE SCHEDULE								
US STRUCTURE DS		DS	INVERT START	INVERT END	·	PIPE		
I.D.	RIM	STRUCTURE	INVERTI START	TIANT INVENTIGIO	SLOPE (FT/FT)	LENGTH (FT)	DIAMETER (IN)	NOTES
CB-1	61.43	DMH-1	55.55	55.00	0.037	15	12	
CB-2	61.28	DMH-1	56.35	55.00	0.040	34	12	
DMH-1	61.31	DMH-2	54.90	48.90	0.039	155	12	
DMH-2	57.13	DMH-3	48.90	47.90	0.021	47	12	
CB-3	53.85	DMH-3	50.06	49.70	0.005	78	12	
CB-4	53.85	DMH-3	49.43	47.90	0.019	81	15	
DMH-3	54.52	CDS-1	47.90	47.20	0.023	31	18	
CB-5	53.18	DMH-4	48.00	47.30	0.030	23	12	
CB-6	53.21	DMH-4	48.00	47.30	0.054	13	12	
DMH-4	52.70	CDS-1	47.30	47.20	0.012	8	12	
CDS-1	53.00	SSI-1	47.20	47.00	0.020	10	18	
SSI-1	_	0CS-1	48.50	47.80	0.088	8	12	
0CS-1	52.50	DMH-5	47.00	45.72	0.028	46	12	
CB-7	48.44	DMH-6	44.20	44.08	0.015	8	12	
CB-8	48.42	DMH-6	44.31	44.08	0.013	18	12	
DMH-5	50.00	DMH-6	45.72	44.08	0.016	105	12	
DMH-6	48.36	CDS-2	44.08	42.43	0.010	172	12	
CB-9	45.62	CDS-2	42.10	41.85	0.011	23	15	
CDS-2	45.85	SSI-2	41.85	41.50	0.088	4	15	
SSI-2	_	0CS-2	42.60	42.20	0.080	5	12	
0CS-2	46.28	HW-1	42.20	41.75	0.026	17	12	


AT

303 & 333 PERKINS ROW

(ASSESSOR'S MAPS 27 & 20, LOT 43)
TOPSFIELD, MASSACHUSETTS

PREPARED FOR BURHANI, LLC

OCTOBER 16, 2017

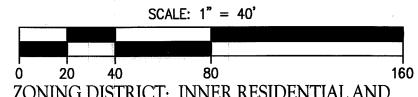

ZONING DISTRICT: INNER RESIDENTIAL AND AGRICULTURE (IRA) / OUTLYING RESIDENTIAL AND AGRICULTURAL (ORA)

Morin-Cameron

GROUP, INC.

CIVIL ENGINEERS | ENVIRONMENTAL CONSULTAN

LAND SURVEYORS | LAND USE PLANNERS

CIVIL ENGINEERS | ENVIRONMENTAL CONSULTANTS LAND SURVEYORS | LAND USE PLANNERS 66 ELM STREET, DANVERS, MASSACHUSETTS 01923 P: 978-777-8586, F: 978-774-3488, W: WWW.MORINCAMERON.COM


MASSACHUSETTS REGISTERED

I HEREBY CERTIFY THAT THIS PLAN HAS BEEN PREPARED IN CONFORMANCE WITH THE RULES AND REGULATIONS OF THE REGISTERS OF DEEDS OF THE COMMONWEALTH OF MASSACHUSETTS.

DATE

PROFESSIONAL ENGINEE	ZR .
l,	CLERK OF THE TOWN OF
TOPSFIELD, HEREBY CEI	RTIFY THAT THE NOTICE OF
APPROVAL OF THIS PLA	AN BY THE PLANNING BOARD
WAS RECEIVED ON	AND RECORDED AT
THIS OFFICE AND NO N	IOTICE OF APPEAL WAS
RECEIVED DURING THE	TWENTY DAYS NET FOLLOWING
SUCH RECEIPT AND RE	CORDING OF SAID NOTICE.

DATE TOWN C	LERK
APPROVED ON	, SUBJECT TO
COVENANTS AND CONE	DITIONS EXECUTED BY
	AND RECORDED IN THE ESSEX
COUNTY REGISTRY OF	DEEDS, SOUTHERN DISTRICT,
BOOK No	, PAGE No
APPROVAL UNDER THE CONTROL LAW REQUIRE	
DATE OF APPLICATION:	OCTOBER 17, 2017
DATE OF HEARING:	
DATE OF APPROVAL:	 !
DATE OF ENDORSEMEN	T:
	- was a second and a

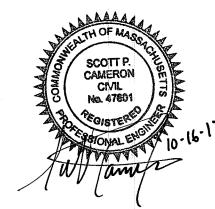

TOPSFIELD PLANNING BOARD

SITE PLAN II

DRAWING NO.

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PROJ. #3460 DRAWNG: 3460 LAYOUT

PROP. DRAIN — MANHOLE (TYP.) 3+80.45 PROP. 8" CLDI WATER MAIN (TYP.) PROP. STORM
DRAIN (TYP.) **/**2+38.57 - -PROP. CATCH BASIN (TYP.) (599.85 LF TO **PERKINS ROW)** PROP. WATER QUALITY SIDEWALK PROP. SUBSURFACE INFILTRATION SYSTEM 4+41.95 \downarrow (SSI-1) 4+70.83 — PROP. 18" HDPE DRAIN PIPE 5+45.74 PROP. 15" HDPE — DRAIN PIPE 5+66.78 ROAD A PROP. <u>PLAN</u> SCALE: 1" = 40' SUBSURFACE INFILTRATION SYSTEM (SSI-2A) LOT 6 -STA 0+00 AT EDGE OF PAVEMENT ₽₽ 111.00VC 293.20SD -4.5% -1.5%

THE CONTROLL PROPERTY OF THE CONTROLL PROPERTY

ROAD A

PROFILE

SCALE: 1"=40' HORIZONTAL

1"=4' VERTICAL

RIVERWOOD ESTATES DEFINITIVE SUBDIVISION


АТ

303 & 333 PERKINS ROW

(ASSESSOR'S MAPS 27 & 20, LOT 43)
TOPSFIELD, MASSACHUSETTS

PREPARED FOR BURHANI, LLC

OCTOBER 16, 2017

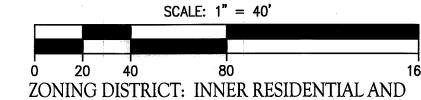

ZONING DISTRICT: INNER RESIDENTIAL AND AGRICULTURE (IRA) / OUTLYING RESIDENTIAL AND AGRICULTURAL (ORA)

Morin-Cameron

GROUP, INC.

CIVIL ENGINEERS | ENVIRONMENTAL CONSULTANTS LAND SURVEYORS | LAND USE PLANNERS 66 ELM STREET, DANVERS, MASSACHUSETTS 01923 P: 978-777-8586, F: 978-774-3488, W: WWW.MORINCAMERON.COM

I HEREBY CERTIFY THAT THIS PLAN HAS BEEN PREPARED IN CONFORMANCE WITH THE RULES AND REGULATIONS OF THE REGISTERS OF DEEDS OF THE COMMONWEALTH OF MASSACHUSETTS.

MASSACHUSETTIS REGISTERED DATE
PROFESSIONAL ENGINEER

I, ______ CLERK OF THE TOWN OF
TOPSFIELD, HEREBY CERTIFY THAT THE NOTICE OF

TOPSFIELD, HEREBY CERTIFY THAT THE NOTICE OF APPROVAL OF THIS PLAN BY THE PLANNING BOARD WAS RECEIVED ON ______ AND RECORDED AT THIS OFFICE AND NO NOTICE OF APPEAL WAS RECEIVED DURING THE TWENTY DAYS NET FOLLOWING SUCH RECEIPT AND RECORDING OF SAID NOTICE.

COVENANTS AND CONDI	ND RECORDED IN THE ES
	EEDS, SOUTHERN DISTRIC , PAGE No
APPROVAL UNDER THE S	SUBDIVISION
DATE OF APPLICATION:	OCTOBER 17, 2017
DATE OF HEARING:	-
DATE OF APPROVAL:	
DATE OF ENDORSEMENT:	
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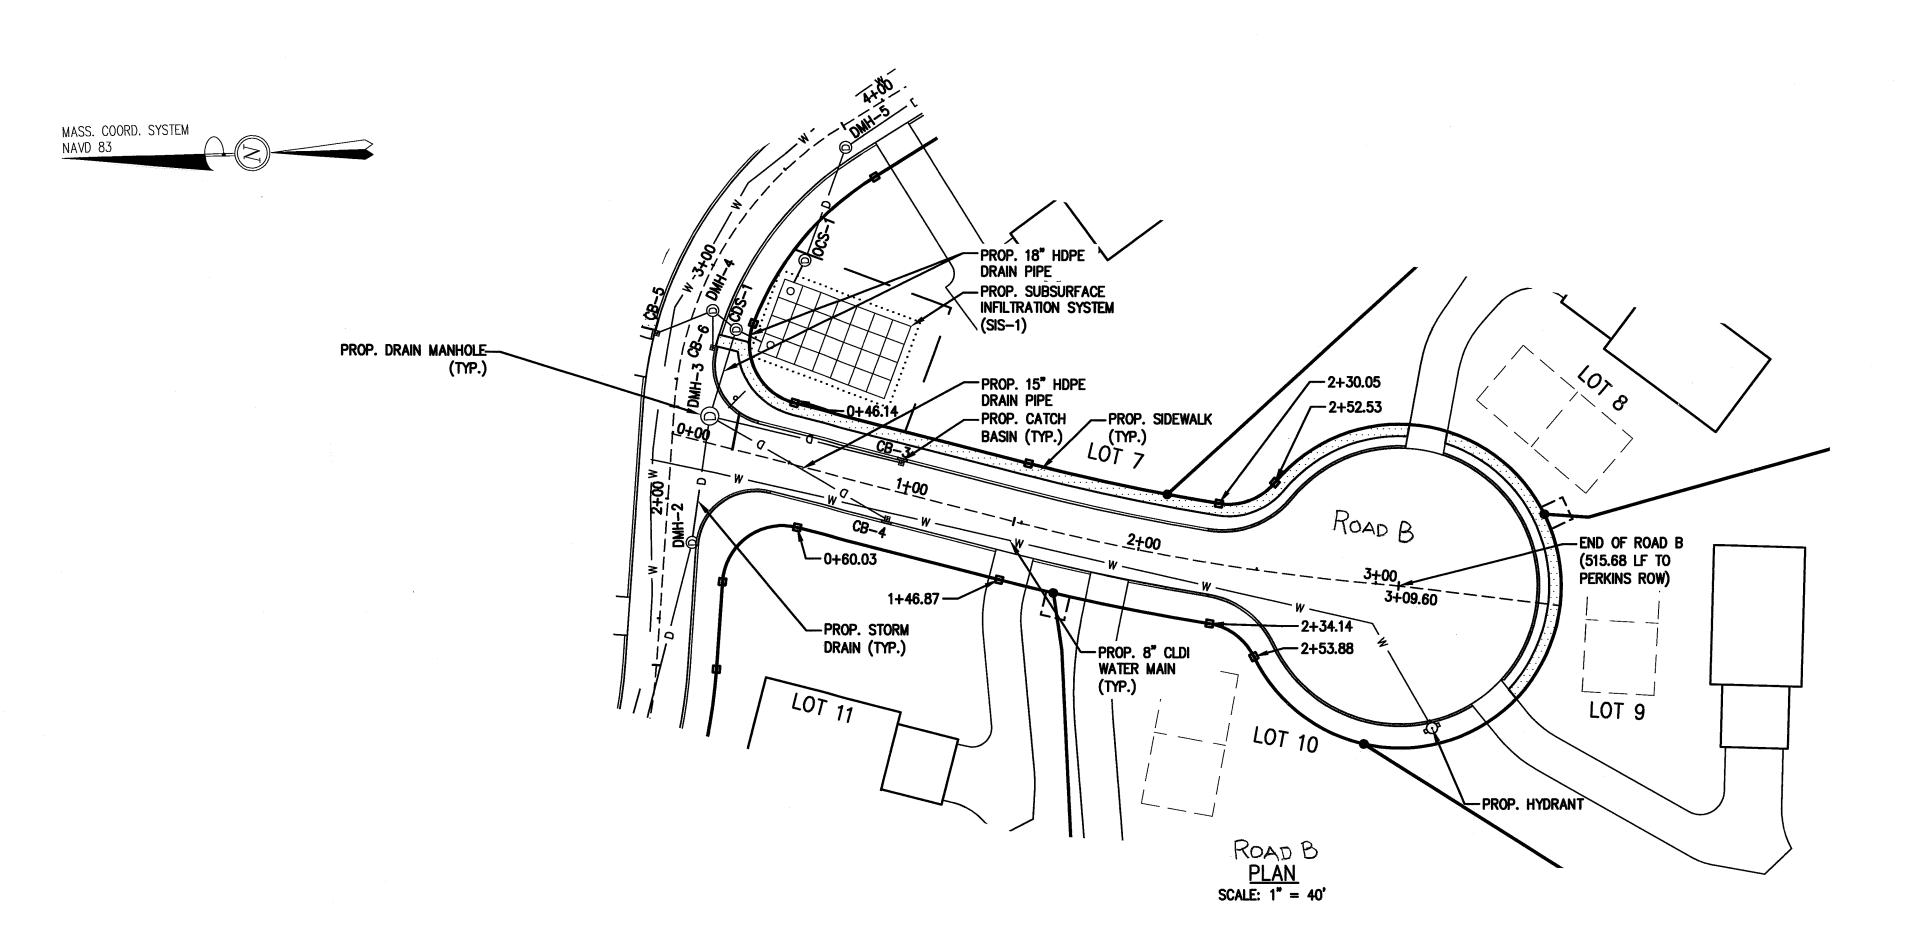



ROAD PLAN AND PROFILE I

DRAWING NO.

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FOR REGISTRY USE ONLY



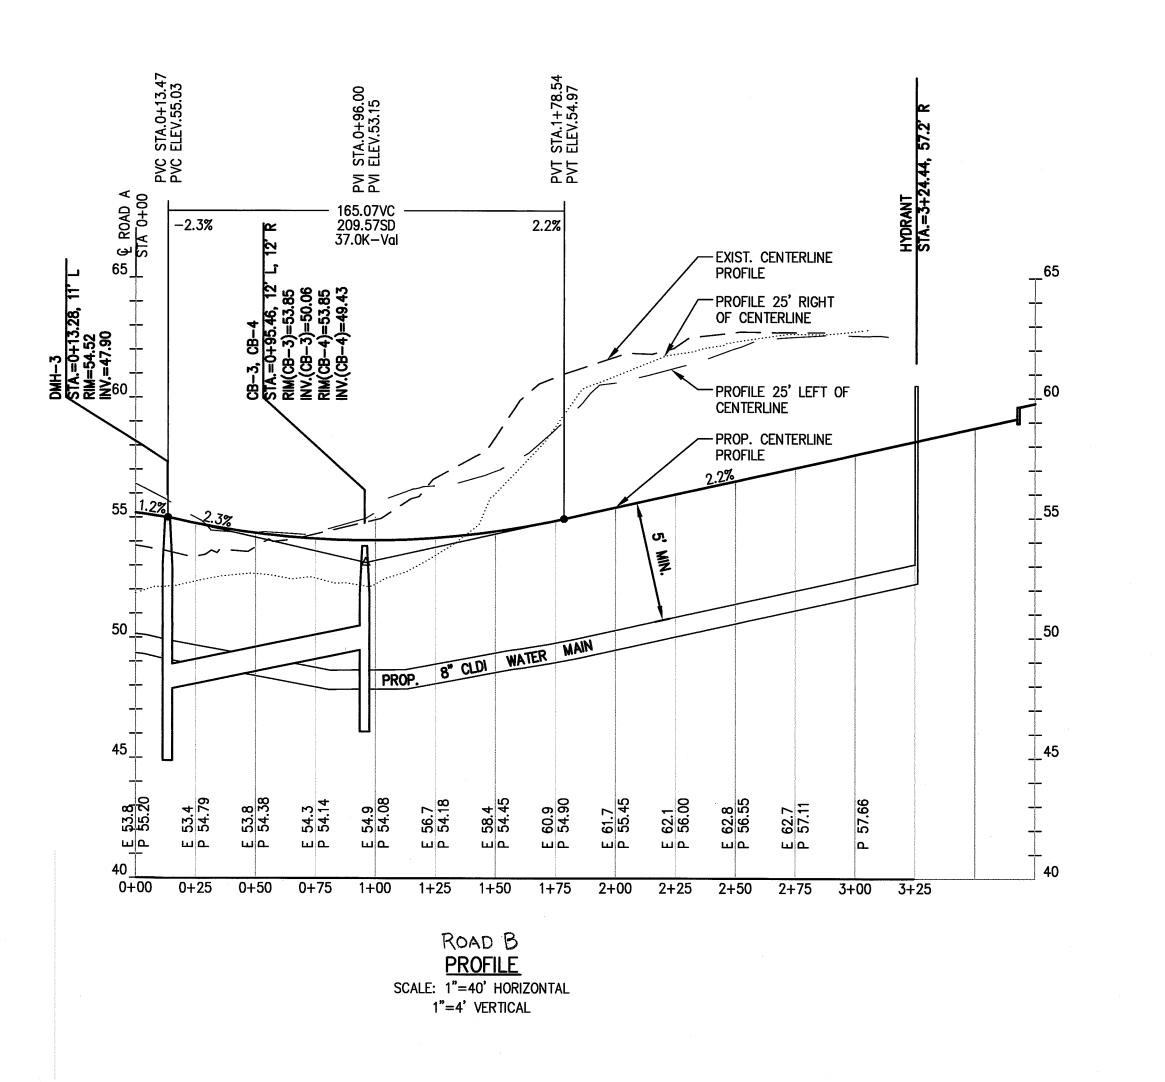


AT

303 & 333 PERKINS ROW

(ASSESSOR'S MAPS 27 & 20, LOT 43)
TOPSFIELD, MASSACHUSETTS

PREPARED FOR BURHANI, LLC

OCTOBER 16, 2017

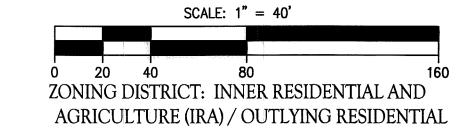


AND AGRICULTURAL (ORA)

Morin-Cameron

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I, _____ CLERK OF THE TOWN OF TOPSFIELD, HEREBY CERTIFY THAT THE NOTICE OF APPROVAL OF THIS PLAN BY THE PLANNING BOARD WAS RECEIVED ON _____ AND RECORDED AT THIS OFFICE AND NO NOTICE OF APPEAL WAS RECEIVED DURING THE TWENTY DAYS NET FOLLOWING SUCH RECEIPT AND RECORDING OF SAID NOTICE.

ATE OF HEARING: ATE OF APPROVAL:			EDS, SOUTHERN DISTRICT, PAGE No
1			UBDIVISION
ATE OF APPROVAL:	DATE OF AP	PLICATION:	OCTOBER 17, 2017
	DATE OF HE	ARING:	
ATE OF ENDORSEMENT:	DATE OF AP	PROVAL:	i.
	DATE OF EN	DORSEMENT:	

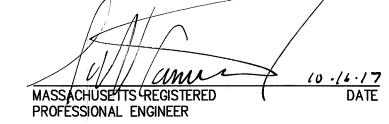

TOPSFIELD PLANNING BOARD

ROAD PLAN AND PROFILE II

DRAWING NO.

15 of 20

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PROJ. #3460 DRAWING: 3460 LAYOUT

